set issue date 08/16/22

06/21/22

A000




BROOKLINE STREET

STREET

sheet issue date 06/08/22

Sheet no.

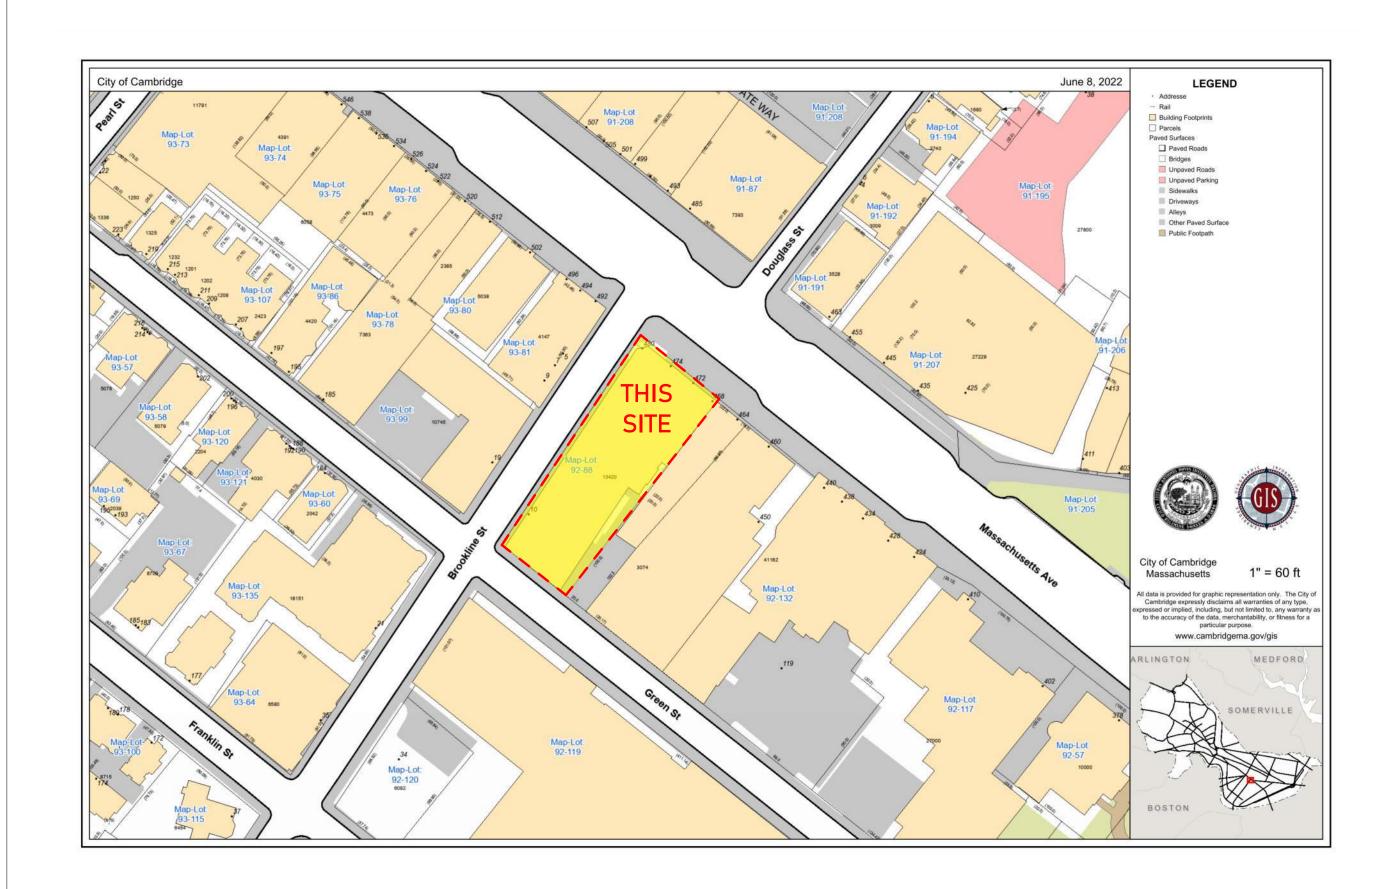

S

9

OPERTY

 $\mathbf{\alpha}$ 血

22050

1" = 100'-0" set issue date

08/16/22 sheet issue date 08/16/22

Sheet no.

A002



NOTES:

1. BENCH MARK INFORMATION:

ELEVATION DATUM TAKEN FROM FELDMAN JOB #11737.

TEMPORARY BENCH MARKS SET:


2. ELEVATIONS REFER TO CAMBRIDGE CITY BASE (CCB).

SEWER MANHOLE

- 3. CONTOUR INTERVAL EQUALS ONE (1) FOOT.
- BY GRAPHIC PLOTTING ONLY, THE PARCEL SHOWN HEREON LIES WITHIN A ZONE "X" (UNSHADED), AN AREA OUTSIDE OF THE 0.2% ANNUAL CHANCE FLOOD, AS SHOWN ON THE FEDERAL EMERGENCY MANAGEMENT ACREVEY (F.E.M.A) FLOOD INSURANCE RATE MAP (F.E.M.A) FLOOD INSURANCE RATE MAP (F.E.M.A) FLOOD INSURANCE CONTROL OF COMMENDED COMMUNITY NUMBER 250188, PANEL NUMBER 2507578, HAVING AN EFFECTIVE DATE OF JUNE 4, 2010.
- THIS DOCUMENT IS AN INSTRUMENT OF SERVICE OF FELDMAN GEOSPATIAL ISSUED TO OUR CLENT FOR PURPOSES RELATED DIRECTLY AND SOLELY TO FELDMAN GEOSPATIAL IS SOLDE TO SERVICES UMBER CONTRINCT TO OUR CLUENT FOR THIS PROJECT. ANY USE OR REUSE OF THIS PROJECT, ANY USE OR REUSE OF THIS SOCIETY OF THE PROVINCE OWNERS OF ANY PARTY FOR PURPOSES UMBERITED DIRECTLY AND SOLELY TO SAU CONTRICT SHALL BE AT THE USER'S SOLE AND EXCLUSIVE PISK AND LIBBUTY, NOLLOWIS LIBBUTY FOR VIOLATION OF COPYRIGHT LAWS, UNLESS WRITTEN CONCRETATION FOR VIOLATION OF COPYRIGHT LAWS, UNLESS WRITTEN CONCRETATION OF COPYRIGHT LAWS, UNLESS WRITTEN

LEGEND

0	DRAIN MANHOLE	BC	BOTTOM OF CURB
	ELECTRIC MANHOLE		BITUMINOUS
(T)	TELEPHONE MANHOLE	8K	BACK
ĕ	MANHOLE	CC	CONCRETE CURB
	HYDRANT	CLF	CHAIN LINK FENCE
	71101011	CONC	CONCRETE
ů –	WATER SHUT OFF/WATER GATE	COL	COLUMN
or	GAS SHUT OFF/GAS GATE	CRW	CONCRETE RETAINING WALL
₩	CATCH BASIN	EN7:	ENTRANCE
m	D-FRAME CATCH BASIN	FFE	FINISH FLOOR ELEVATION
•	TRAFFIC SIGNAL	FGC	FLUSH GRANITE CURB
Ď.	LIGHT POLE	HP	HAND RAIL
	WALK LIGHT	J=	INVERT ELEVATION
HHI	ELECTRIC HANDHOLE	INACC.	INACCESSIBLE
•	BOLLARD	JBAR	JERSEY BARRIER
	POST	LCC	LAND COURT CASE
ung		MBTA	MASSACHUSETTS BAY TRANSPORTATION AUTHOR
0		NVP	NO VISIBLE PIPES
	CLEAN OUT	OV	OVER
	COAL CHUTE	R=	RIM ELEVATION
6 FA	FIRE ALARM	(REC)	RECORD
	BIKE RACK	SWL	SOLID WHITE LINE
	ROOF DRAIN	SQ. FT.	SQUARE FEET
	PARKING METER	7BM	TEMPORARY BENCH MARK
	VENT	TC	TOP OF CURB
	COPPER DISC	TH	THRESHOLD
(T)(1)		TOW	TOP OF WATER
	SECURITY CAMERA		TOP OF TRAP
	FLOOD LIGHT		TOP OF WALL
	TRANSFORMER		VERTICAL GRANITE CURB
	GAS METER	WF	WOOD FENCE
	TRASH RECEPTACLE		WROUGHT IRON FENCE
8	DECIDUOUS TREE		- CABLE TELEVISION
1		D	
8)	HANDICAP RAMP		- ELECTRIC
		G	
	GATE POST		- SEWER
ES .	IRRIGATION CONTROL VALVE		- TELEPHONE
0	CURB RETURN		
8	SPRINKLER CONNECTION	S(ABD)	
	JERSEY BARRIER		- PIPE SIZE AND MATERIAL
	VENJET BRINER		
			- DUCTILE IRON
		-xx	
		-0000-	
		-111	- WROUGHT IRON FENCE

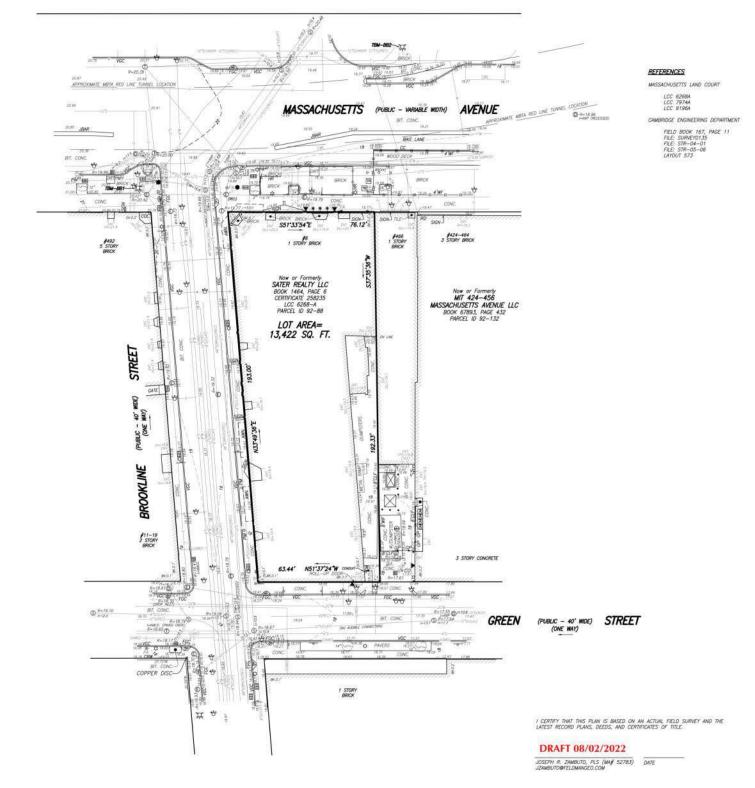


BYSHOP ALLEN DR LOCUS LOCUS MAP NOT TO SCALE

6 BROOKLINE STREET

RESEARCH: CEM	FIELD CHIEF: BB
PROJ MGR: JRZ	APPROVED:
CALC: CEM	CADD: CEM
FIELD CHK:	CRD FILE: 2200677

TELD CHK:	CRD FILE: 2200677
REVISIONS:	
19	
DRAWING NAME:	

PLAN OF LAND

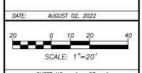

8/16/2022 1:07:04 FM

FELDMIII GEOSPATIA

BOSTON HEADQUARTERS 152 HAMPDEN STREET BOSTON, MA 02119 WORCESTER OFFICE 27 MECHANIC STREET WORCESTER, MA 01608 (617)357-9740 www.feldmangeo.com

CAMBRIDGE, MASS.

200220000000000000000000000000000000000	
CALC: CEM	CADD: CEM
FIELD CHK:	CRD FILE: 2200677
FIELD CHK:	CRD FILE: 22006

EXISTING CONDITIONS

BUILDING AREA SCHEDULE - GFA


1	SI FLOOR	
	MUSIC VENUE	2282 SF
	SERVICE CORRIDOR	1069 SF
	TRASH	400 SF
	CIRC	400 SF
	LOBBY	679 SF
		4830 SF

2ND FLOOR	
GUEST ROOMS	10429 SF
	10429 SF
3RD FLOOR	
GUEST ROOMS	10436 SF
	10436 SF

4TH FLOOR	
GUEST ROOMS	10425 SF
	10425 SF
5TH FLOOR	
GUEST ROOMS	10422 SF
	10422 SF

6TH FLOOR	
KITCHEN	1605 SF
CIRCULATION	415 SF
RESTROOMS	239 SF
RESTROOMS	244 SF
MECH	160 SF
BAR/RESTAURANT	4184 SF
CIRCULATION	458 SF

7305 SF 53847 SF

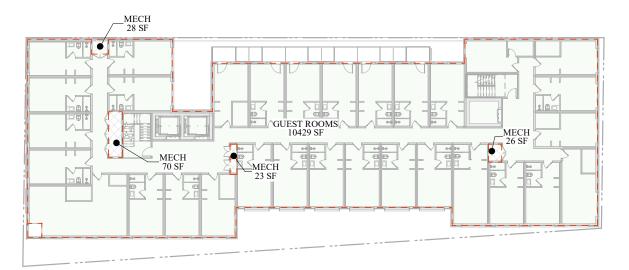

2ND FLOOR 1/32" = 1'-0"

1/32" = 1'-0"

LOADING AREA 1100 SF SERVICE CORRIDOR-1069 SF CIRC 400 SF MUSIC VENUE 2282 SF ELECTRICAL 799 SF RETAIL 1500 SF 1ST FLOOR

STAGE 388 SF MECH 1393 SF STORAGE 1463 SF ELEV 128 SF MUSIC VENUE___ 4149 SF CIRC 531 SF RESTROOMS 889 SF HOTEL BOH 1995 SF BAR 327 SF BASEMENT LEVEL 1/32" = 1'-0"

CSQ REALTY LLC

CALCULATIONS STREET AREA BROOKLINE **ZONING**

9

job number

22050 1/32" = 1'-0"

set issue date 08/16/22

sheet issue date 11/03/17

Sheet no.

ZONING AREA
Project 6 BROOKLINE

igh architects, lic

2205


1/32" = 1'-0" set issue date 08/16/22


sheet issue date 06/02/22

Sheet no.

3RD FLOOR 1/32" = 1'-0"


A011

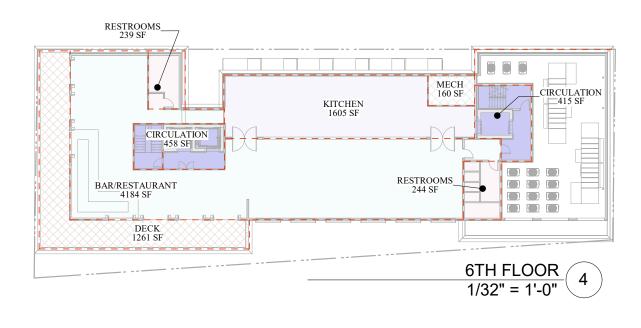

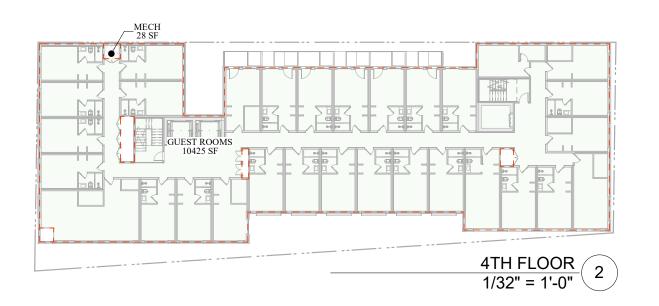

_MECH 28 SF

GUEST ROOMS 10436 SF

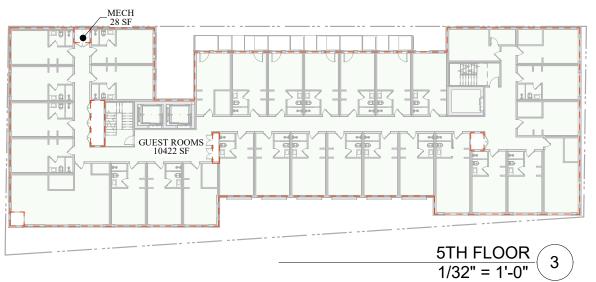

8/16/2022 1:07:48 PM

6 BROOKLINE STREET

22050


set issue date 08/16/22

Sheet no.


08/15/22

A012

SITE PHOTOS

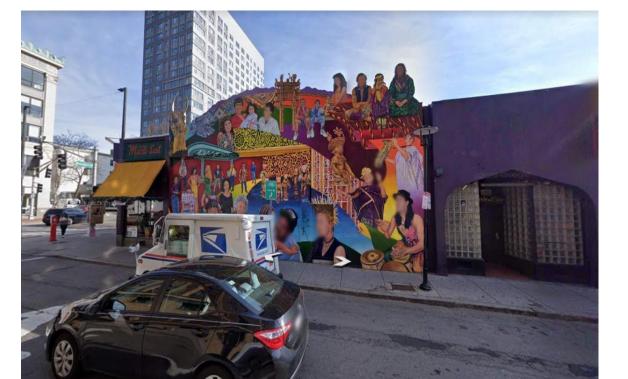


VIEW FROM BROOKLINE STREET

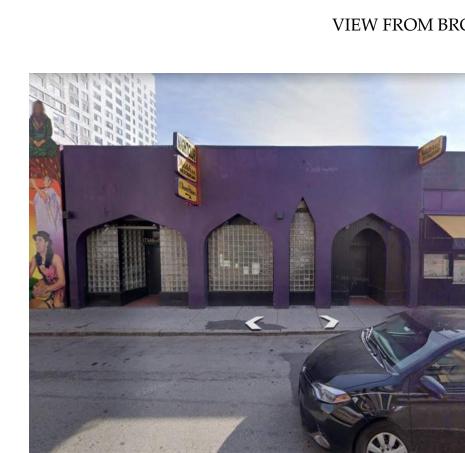

VIEW FROM BROOKLINE STREET



VIEW OF SUBJECT PROPERTY FROM MASS AVE

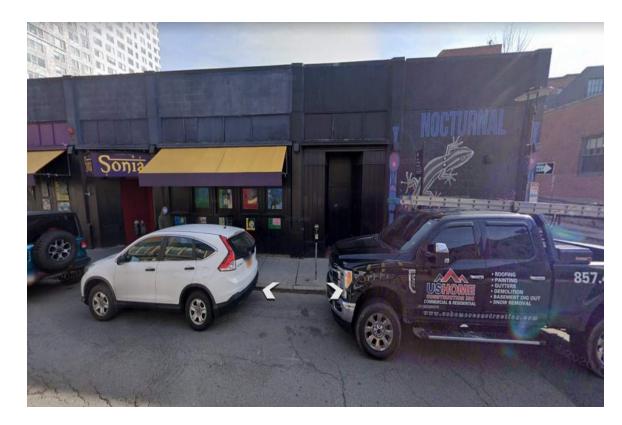

VIEW FROM BROOKLINE STREET

08/15/22

Sheet no.




494 MASS AVE



VIEW SOUTHEAST FROM BROOKLINE STREET



VIEW OF PROPERTY FROM GREEN STREET

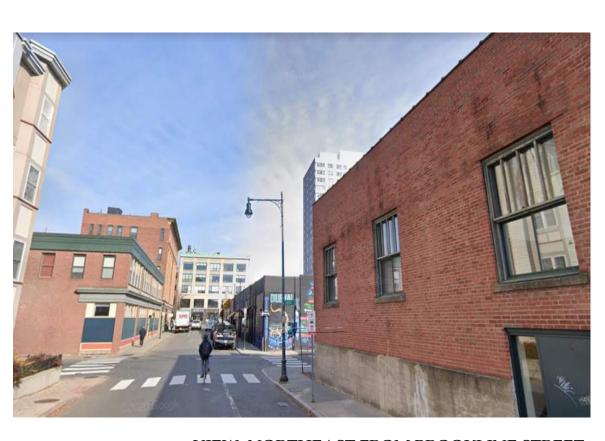

VIEW NORTHEAST FROM BROOKLINE STREET

08/16/22

Sheet no. A014



428 MASS AVE



VIEW NORTHWEST FROM MASS AVE



440 MASS AVE



VIEW SOUTHEAST FROM MASS AVE

CSQ REALTY LLC

6 BROOKLINE STREET SITE PLAN

22050

1" = 50'-0" set issue date 08/16/22

sheet issue date 11/03/17

Sheet no. A100

job number

job number 22050

scale 1/16" = 1'-0"


set issue date 08/16/22

sheet issue date 11/03/17

Sheet no.

BASEMENT LEVEL 1/16" = 1'-0"

A101

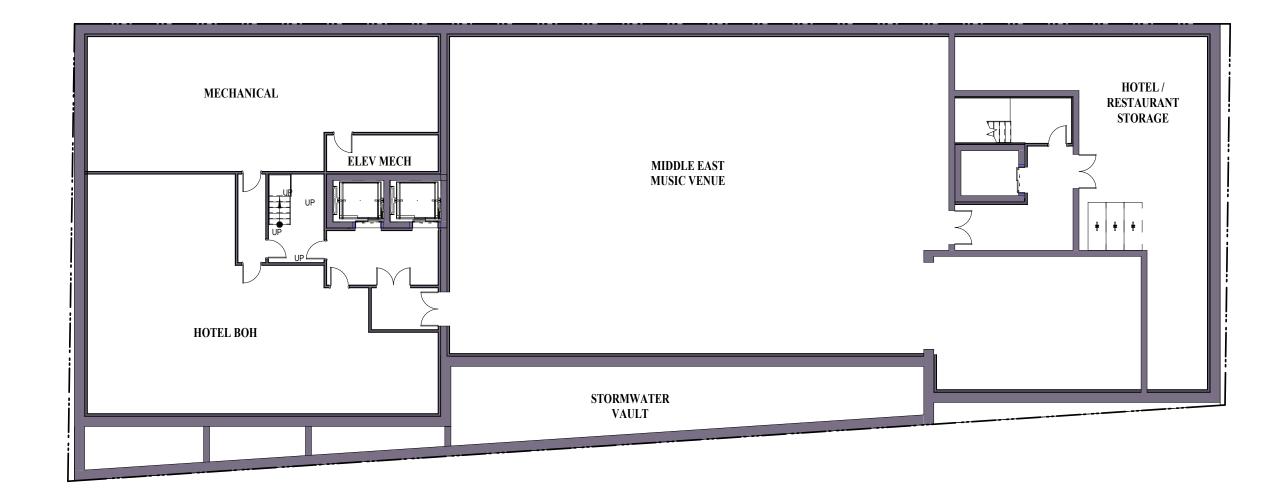

8/16/2022 1:08:02 FM

8/16/2022 1:08:03 FM


6 BROOKLINE STREET

22050

scale 1/16" = 1'-0"

set issue date 08/16/22

sheet issue date 11/03/17

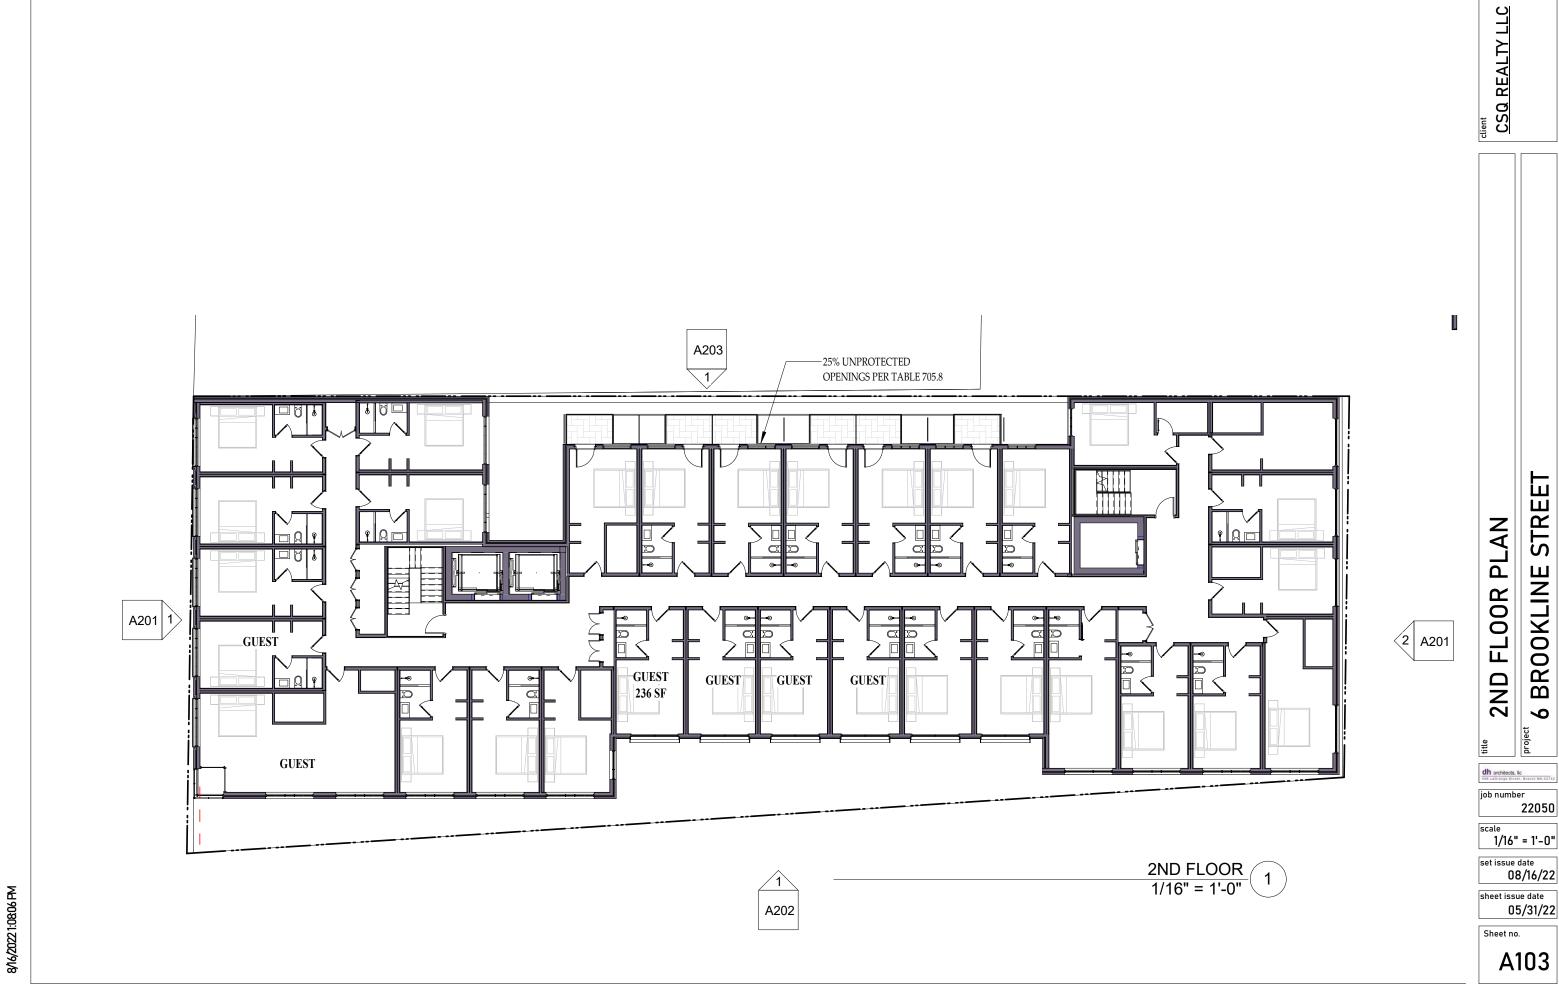

6 BROOKLINE STREET


dh architects, lic

22050

set issue date 08/16/22

sheet issue date

05/31/22

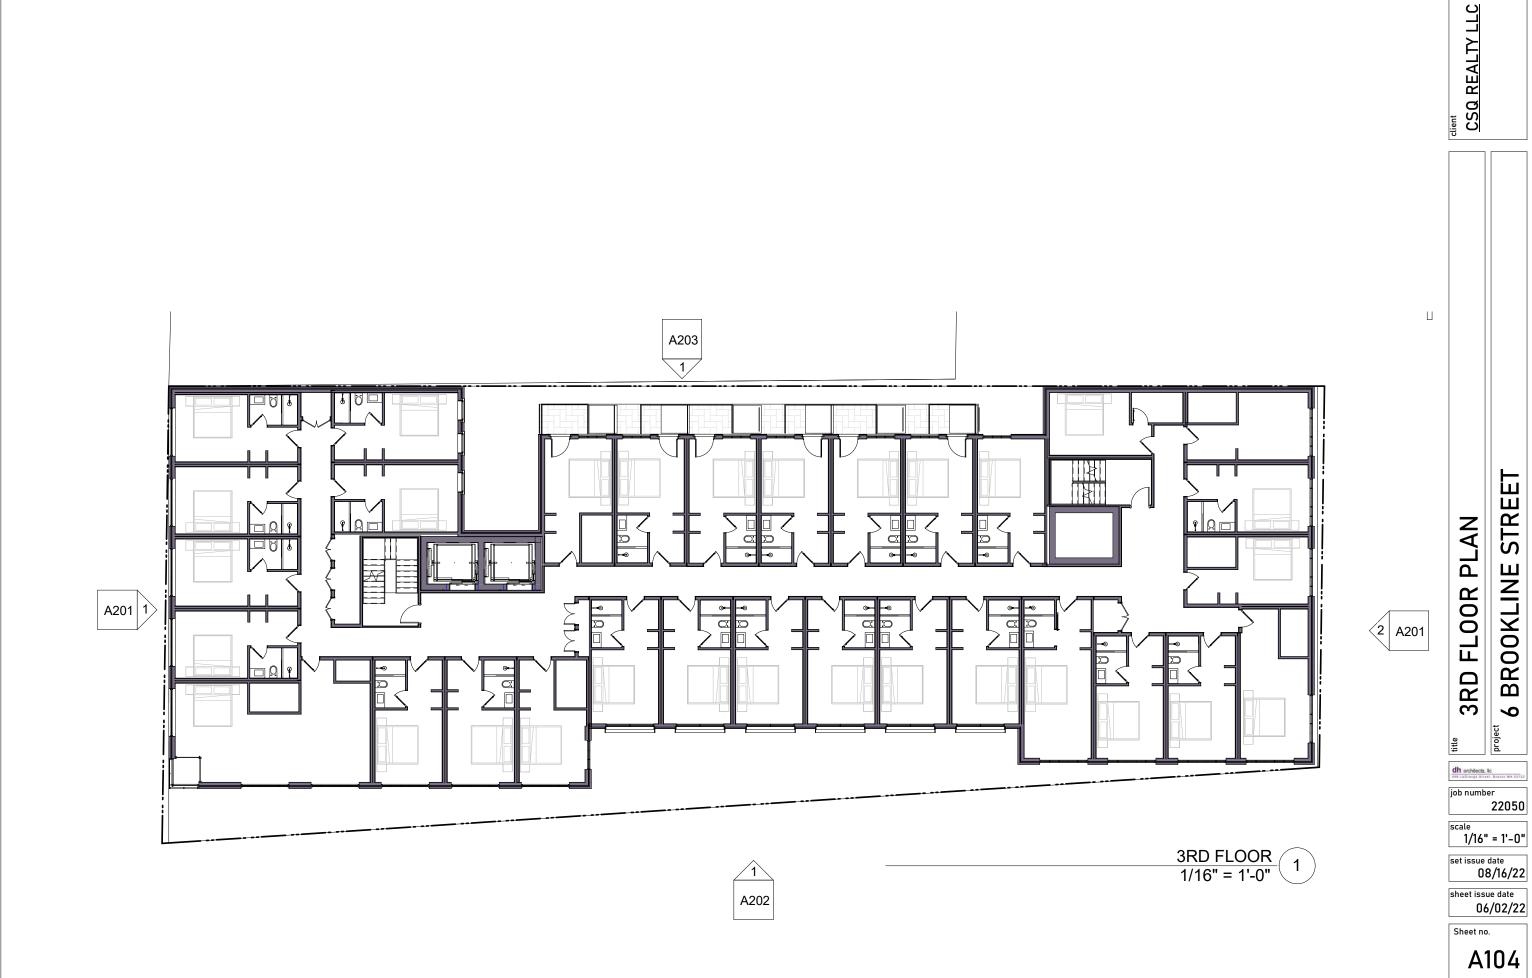

8/16/2022 1:08:10 PM

06/02/22

h architects, Ilc


22050

scale 1/16" = 1'-0"

set issue date 08/16/22

sheet issue date 06/02/22

Sheet no.

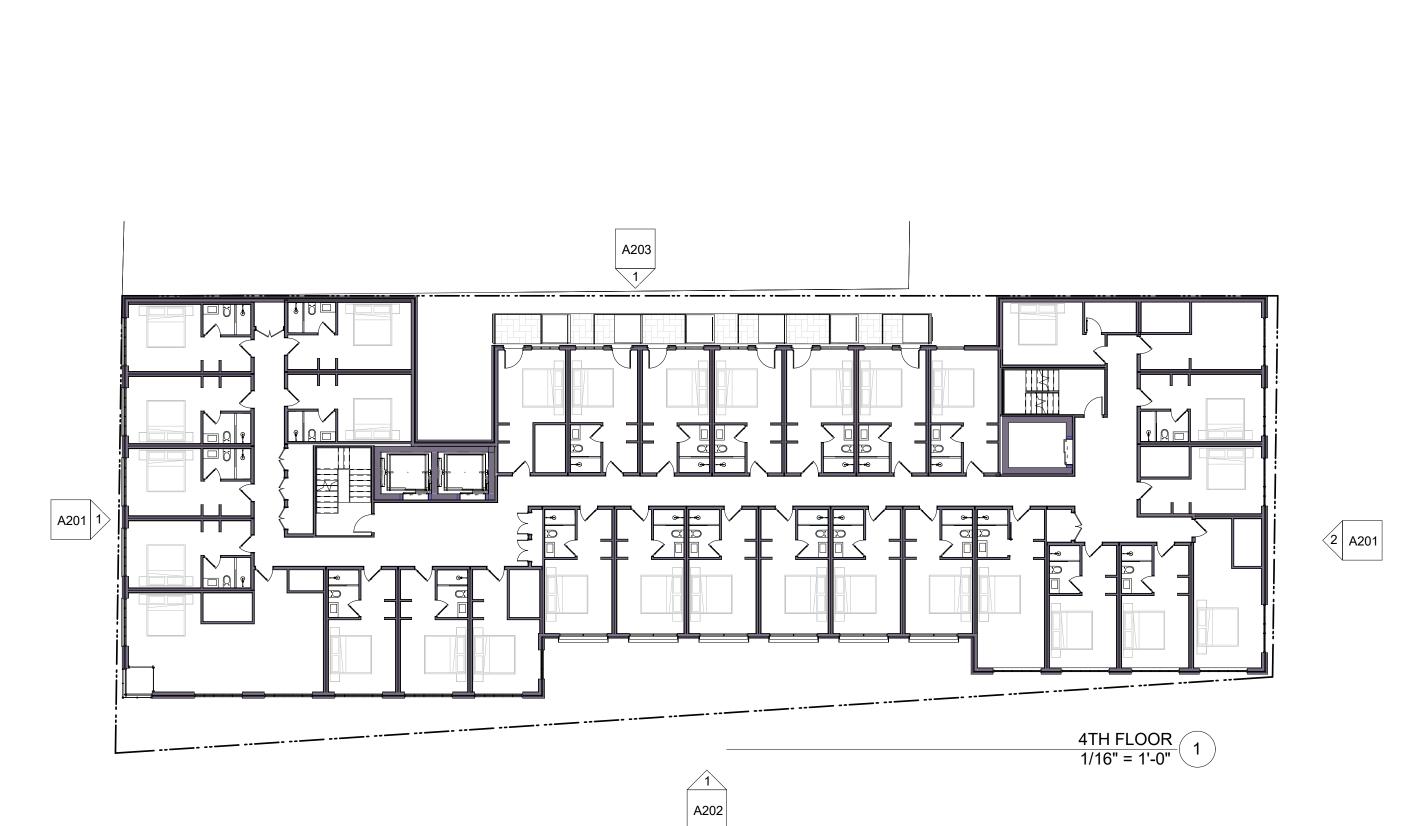

CSQ REALTY LLC

6 BROOKLINE STREET

22050

scale 1/16" = 1'-0"

set issue date 08/16/22

sheet issue date 06/02/22

Sheet no.

job number

22050 scale 1/16" = 1'-0"


set issue date 08/16/22

sheet issue date 06/02/22

Sheet no.

6TH FLOOR 1/16" = 1'-0"

A107

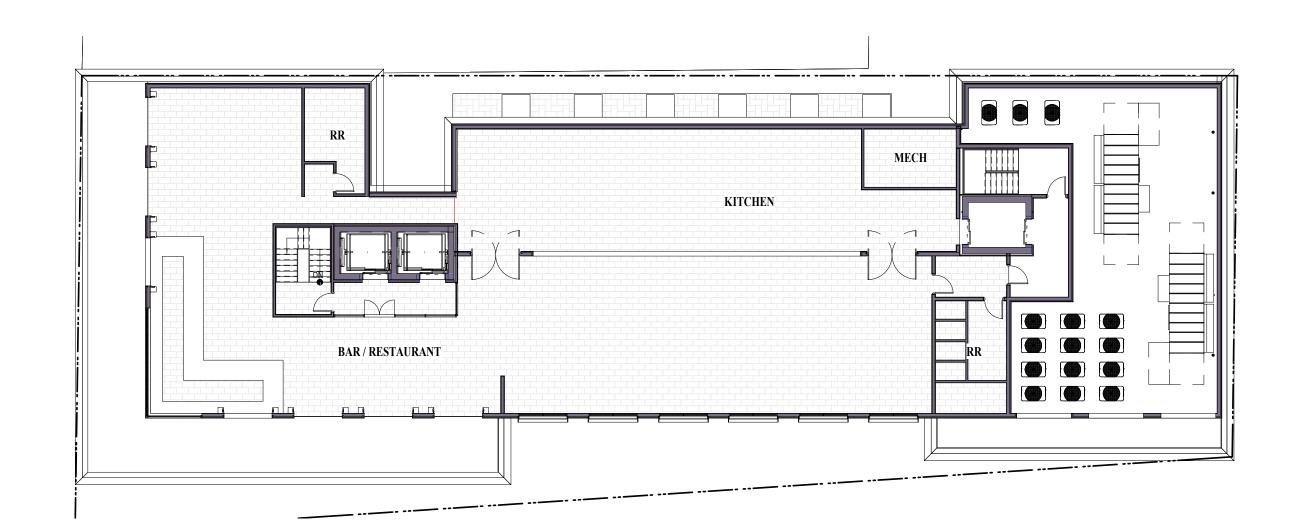

8/16/2022 1:08.19 PM

TOP OF ROOF 80' - 0"

6TH FLOOR 60' - 0"

5TH FLOOR

49' - 0"

4TH FLOOR 38' - 0"

3RD FLOOR 27' - 0"

2ND FLOOR

1ST FLOOR

36' - 0"

MASS AVE ELEVATION

1/16" = 1'-0"

Ш

dh architects, lic


job number 22050


1/16" = 1'-0"

set issue date 08/16/22

sheet issue date 08/15/22

Sheet no. A201

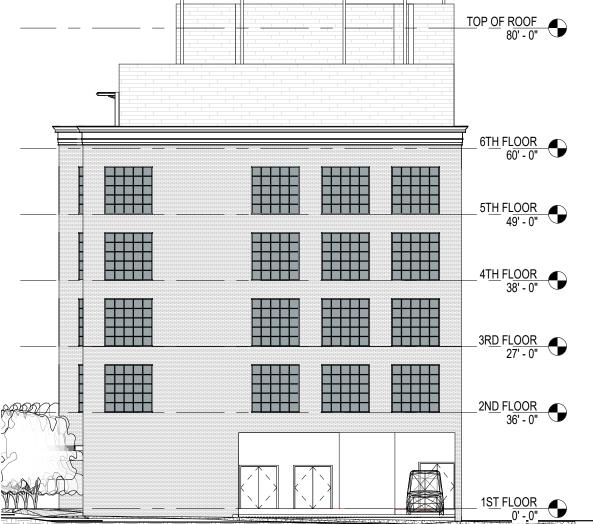

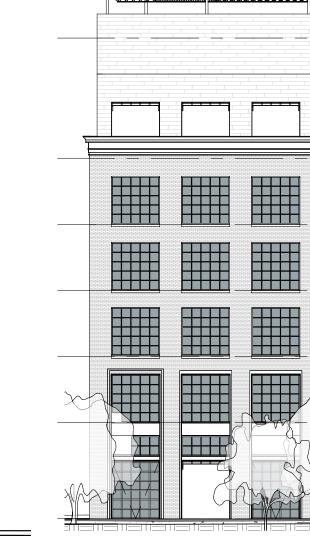

GREEN STREET ELEVATION

1/16" = 1'-0"

Ш

STRI

job number

22050 scale 1/16" = 1'-0"

set issue date 08/16/22

sheet issue date 08/15/22

Sheet no.

BROOKLINE STREET ELEVATION 1/16" = 1'-0"



8/16/2022 1:08:45 PM

CSQ REALTY LLC

PROPOSED BUILDING ELEVATIONS

STREET

BROOKLINE

9

dh architects, lic


job number 22050

ale 1/16" = 1'-0"

set issue date 08/16/22

sheet issue date 08/15/22

Sheet no.

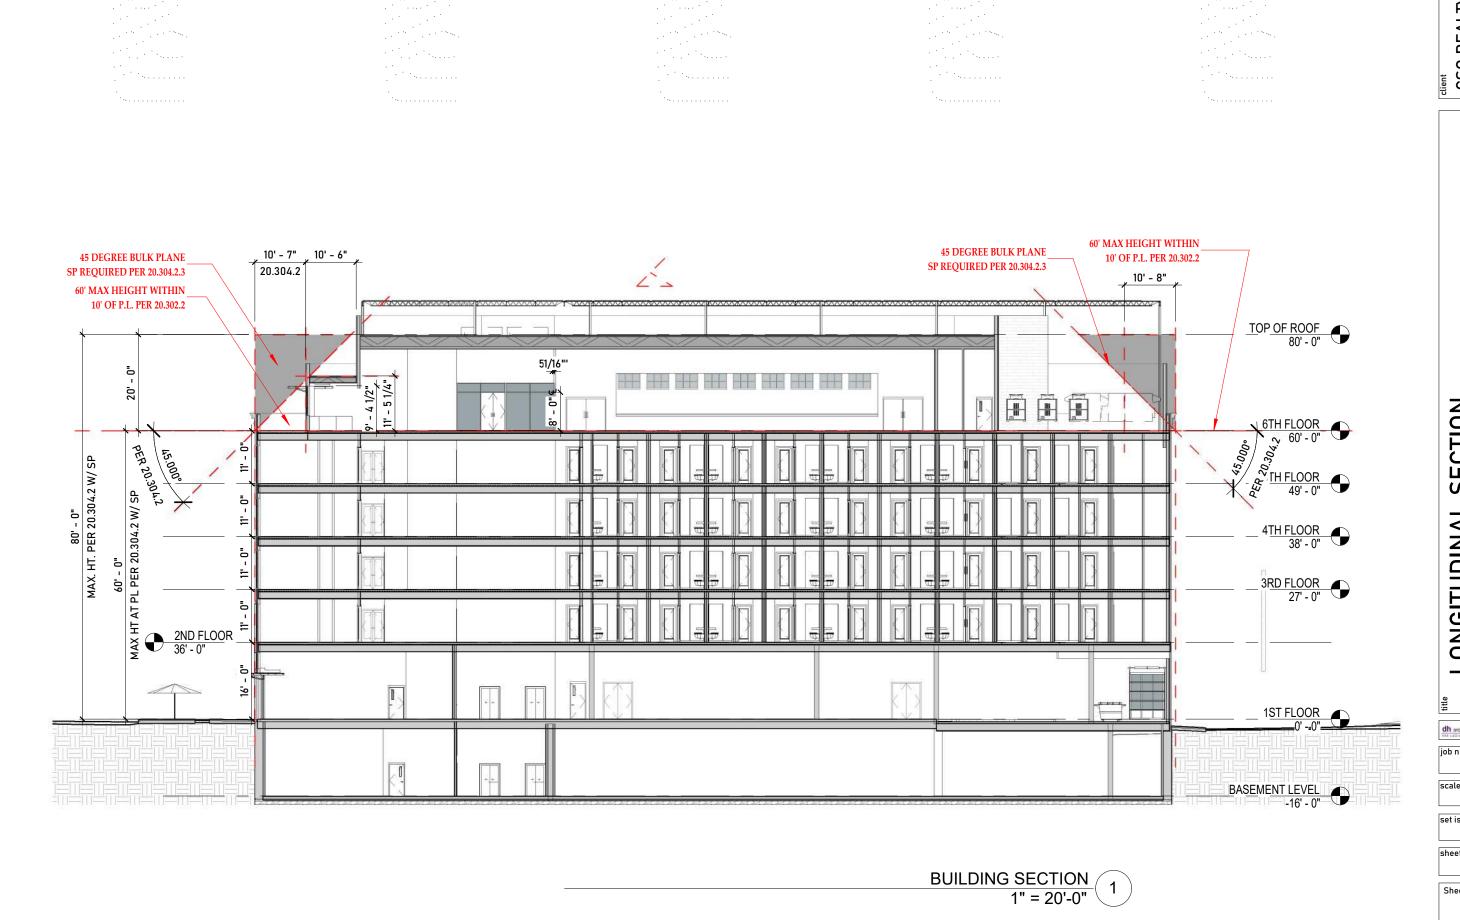

 $(x_{i_1,\ldots,i_n}^{(i_1)},x_{i_1}^{(i_1)},x_{i_2}^{(i_1)},x_{i_3}^{(i_1)},x_{i_4}^{(i_1)},x_{i_4}^{(i_4)},x_{i_5}^{(i_4)})$

 $\gamma_{1,2},\overline{\gamma_{1,2},\gamma_{2,3}}$

8/16/2022 1:08:52 PM

 $\mathbb{R}^{\frac{1}{2}}_{1,2} \times \mathbb{R}^{\frac{1}{2} \times \frac{2}{2} \times \frac{2}{2} \times \frac{2}{2} \times \frac{2}{2}}$

CSQ REALTY LLC

SECTION LONGITUDINAL BROOKLINE project

STREET

9

dh architects, lic job number 22050

1" = 20'-0"

set issue date 08/16/22

sheet issue date

Sheet no.

BROOKLINE STREET

dh architects, lic

job number

scale 1/16" = 1'-0"


set issue date 08/16/22

sheet issue date 11/03/17

Sheet no.

EXISTING BASEMENT LEVEL PLAN
1/16" = 1'-0"

R101

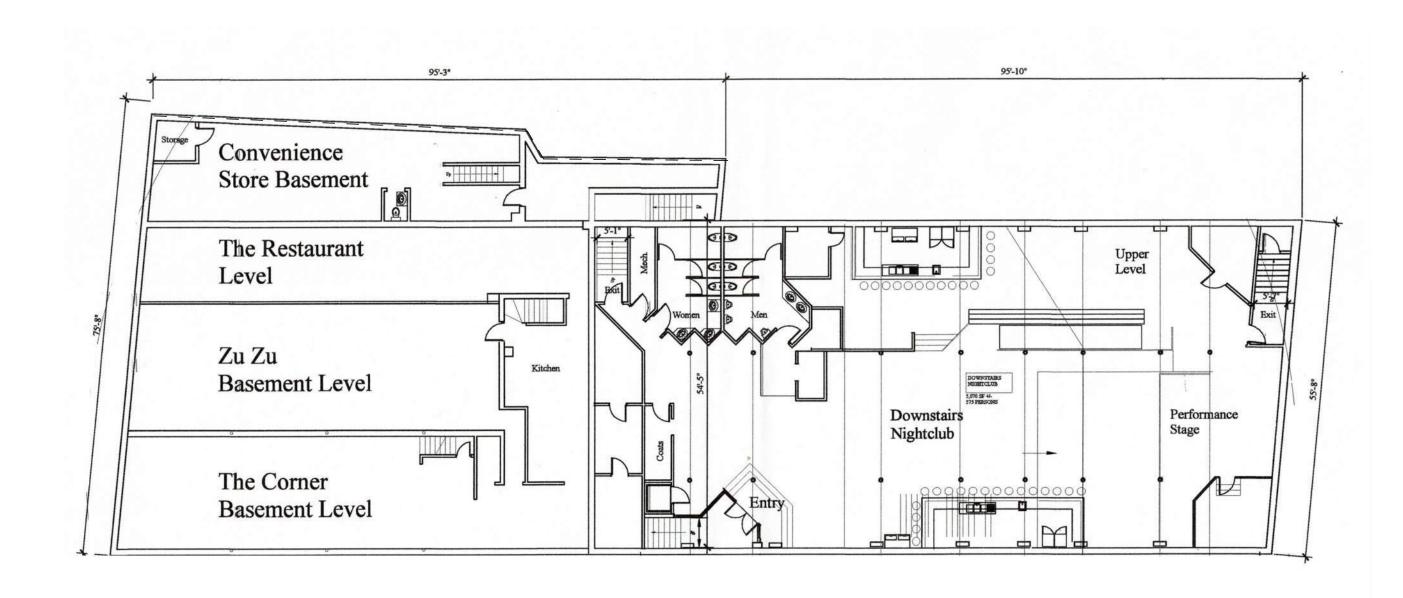

BROOKLINE STREET

dh architects, lic

22050


1/16" = 1'-0"

set issue date 08/16/22 sheet issue date

11/03/17

Sheet no.

R102

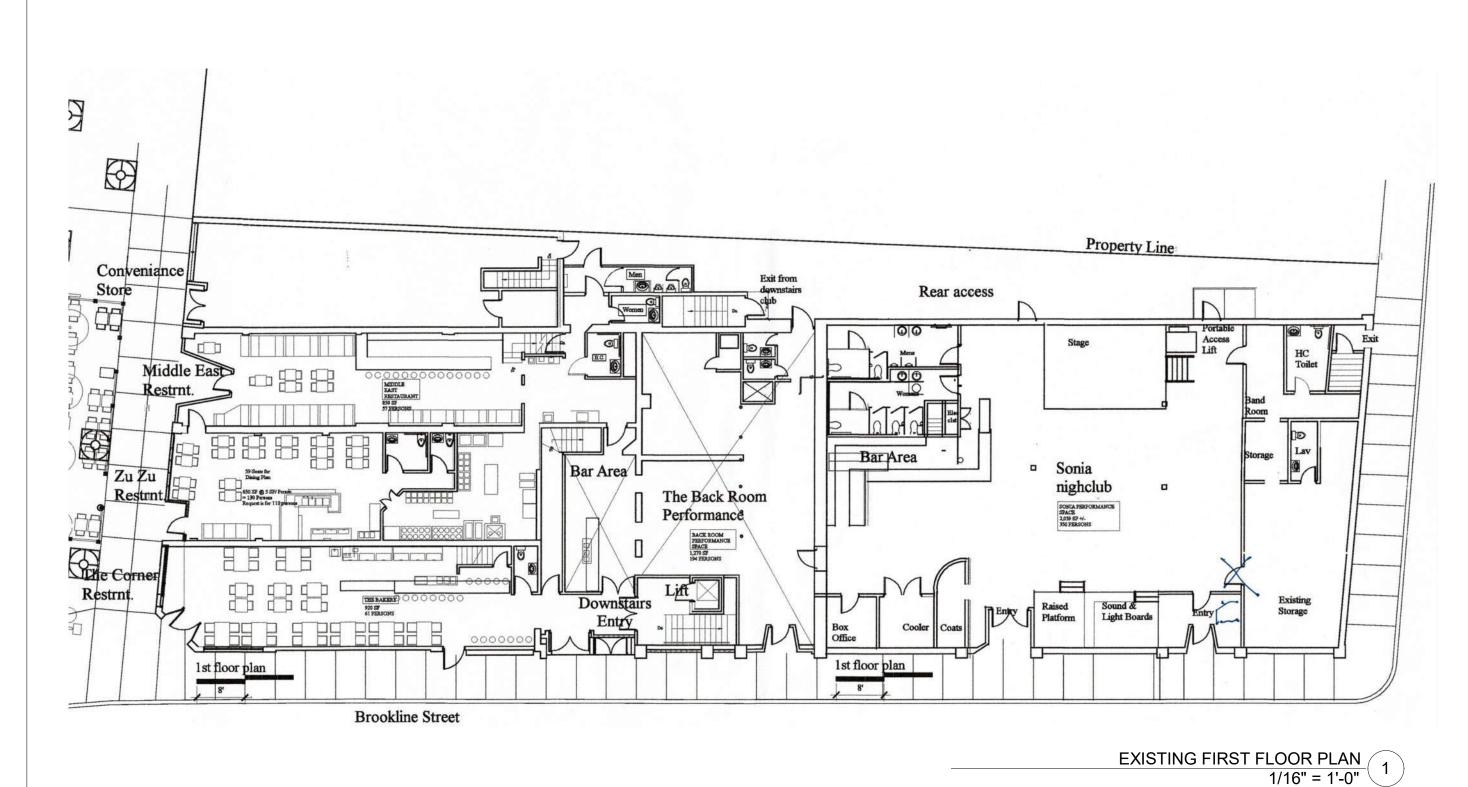

8/16/2022 1:08:53 PM