

2400 Massachusetts Avenue

2400 Mass Ave LLC Article 19 Special Permit Submission Volume 2 - Graphic Volume Submission Date: 5/31/2024 Prepared by: Merge Architects

Collaborating Consultants: Structural Engineer: WSP / Odeh MEPF Engineer: WSP Civil Engineer: Beals and Thomas Landscape Architect: Landworks Studio Sustainability: Linnean Solutions Acoustics: Acentech



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.2


- View From Cedar St
- View From Alberta Terrace
- View From Massachusetts Ave
- View From Harvey St
- View From Pedestrian Retail Corridor
- View Of Pedestrian Retail Corridor From Dwelling Unit
- Color and Material Palette
- Color and Material Palette

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Merge Architects

4/8/2024



 1.1 Existing Site Survey

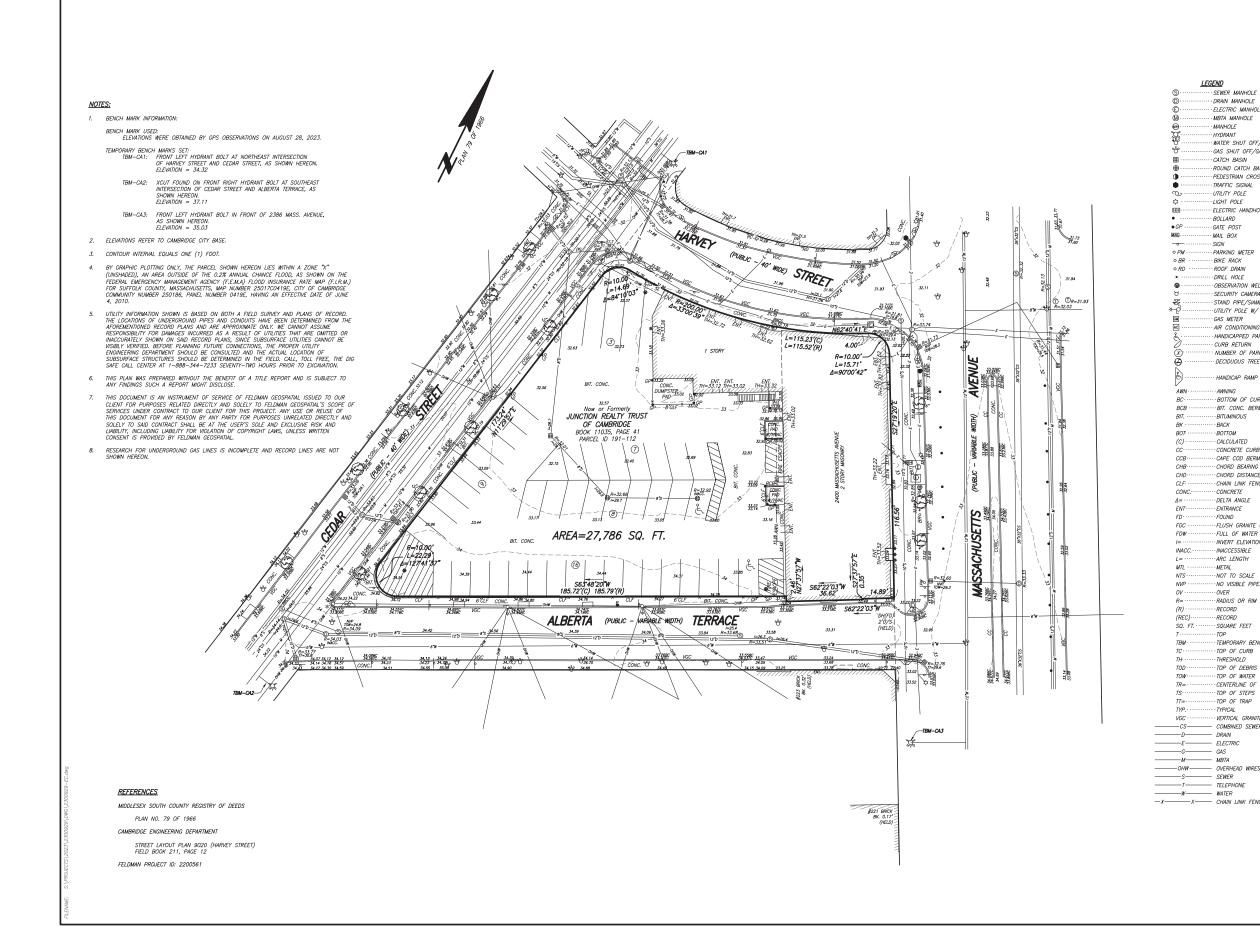 2400 Massachusette Ave

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			CHUSETTS , GE, MASS.	AVE.
	DATE:	SEPT	EMBER 5, 2023	
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2	0		0 20 1"=20'	40
	s	HEET NO.	1 OF 1	

<u>LEGEND</u> ···· SEWER MANHOLE ···· DRAIN MANHOLE

FLECTRIC MANHOLE

WATER SHUT OFF/WATER GATE

GAS SHUT OFF/GAS GATE CATCH BASIN ··ROUND CATCH BASIN ·· PEDESTRIAN CROSSING SIGNAL

MBTA MANHOLE MANHOLE

TRAFFIC SIGNAL · UTILITY POLE LIGHT POLE ·· ELECTRIC HANDHOLE

ROLLARD

·· MAIL BOX

SIGN

GATE POST

··· BIKE RACK ROOF DRAIN

PARKING METER

ORSERVATION WELL SECURITY CAMERA

··UTILITY POLE W/ LIGHT ·GAS METER

AIR CONDITIONING UNIT

CURB RETURN

· DECIDUOUS TREE

HANDICAP RAMP

BIT. CONC. BERM

CONCRETE CURB

CAPE COD BERM CHORD BEARING

·· CHORD DISTANCE ·· CHAIN LINK FENCE ·· CONCRETE

·· DELTA ANGLE

FLUSH GRANITE CURB

FULL OF WATER

·· INVERT ELEVATION

NO VISIBLE PIPES

RADIUS OR RIM ELEVATION

TEMPORARY BENCH MARK

INACCESSIBLE

ARC LENGTH

METAL NOT TO SCALE

OVER

RECORD

RECORD

· · TOP

··SQUARE FEET

TOP OF CURB

·· THRESHOLD ·· TOP OF DEBRIS

... TOP OF WATER CENTERLINE OF TROUGH

TOP OF STEPS TOP OF TRAP TYPICAL VERTICAL GRANITE CURB

COMBINED SEWER

DRAIN

SEWER -T-TELEPHONE

-W-WATER X CHAIN LINK FENCE

----- ELECTRIC GAS MBTA

ENTRANCE

FOUND

BITUMINOUS

AWNING BOTTOM OF CURB

BACK

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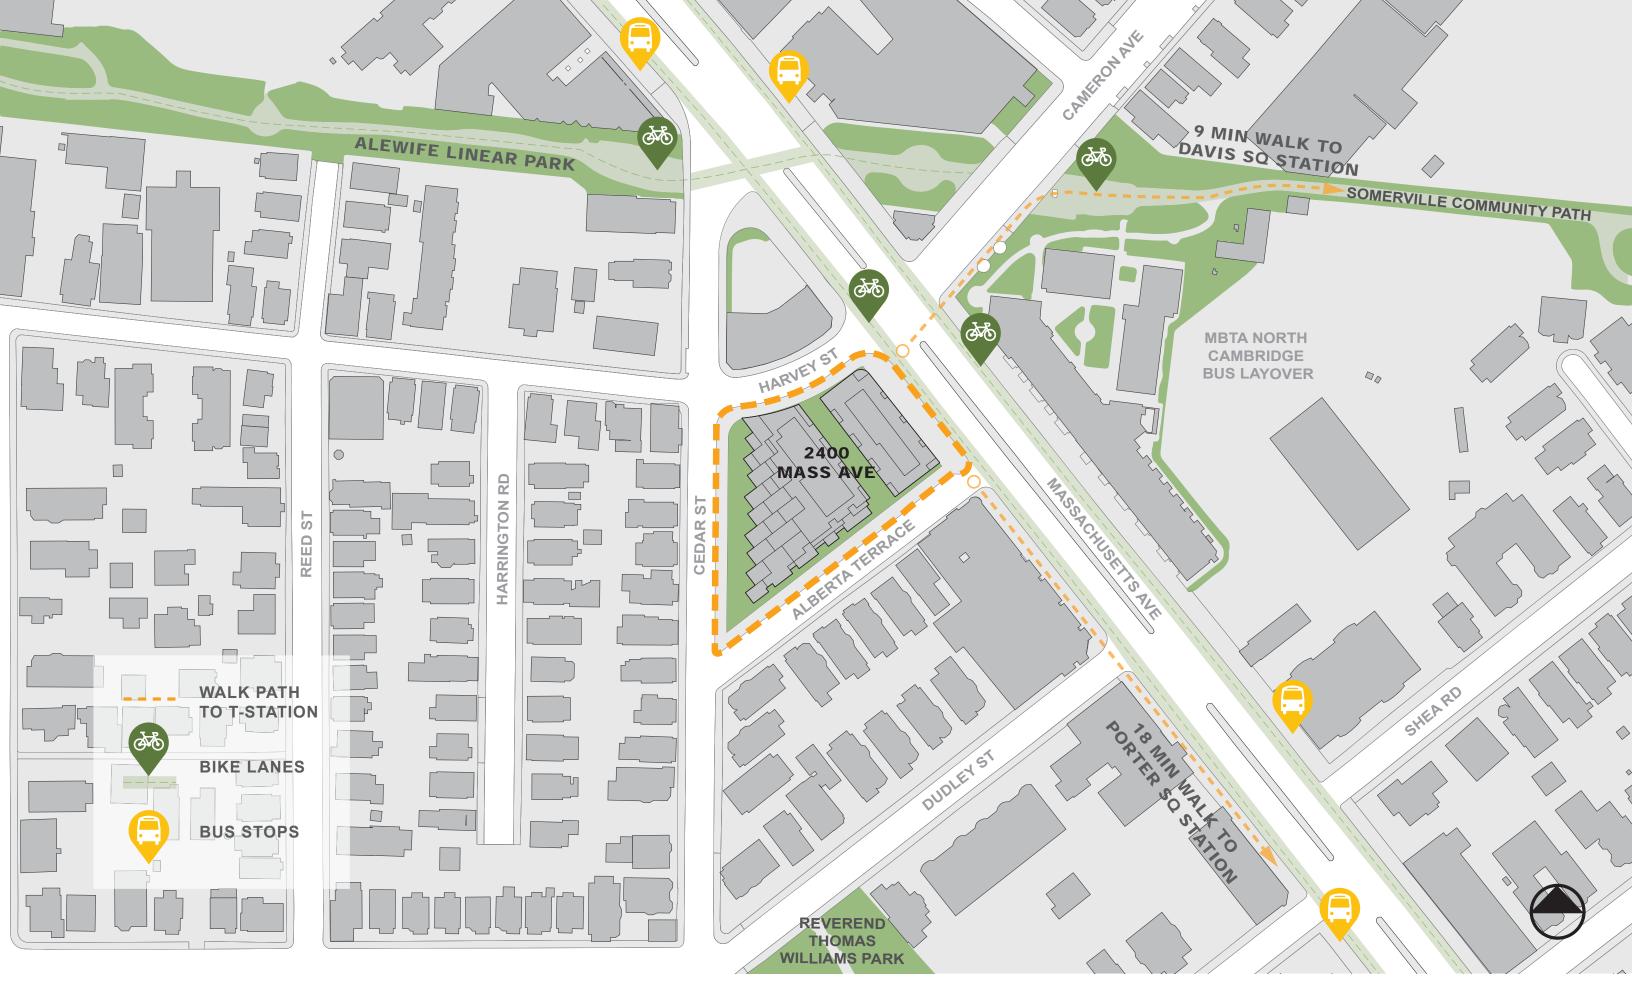
STAND PIPE/SIAMESE CONNECTION

HANDICAPPED PARKING SPACE

NUMBER OF PARKING SPACES

HYDRAN

Feldman Geospatial



1.2 Site Context Map 2400 Massachusetts A

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Mass Ave, Alberta Terrace, Harvey St



Harvey St, Cedar St



Cedar St, Alberta Terrace



1.3 Existing Site Photos

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Alberta Terrace, Cedar St, Harvey St



Mass Ave



Community Path / Linear Park




1.4 Existing Context Photos

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Merge Architects

Cambridge, Massachusetts




B+T Drawing No. 348500P001B-001 Date: 04/04/2024 Scale: 1" = 30'

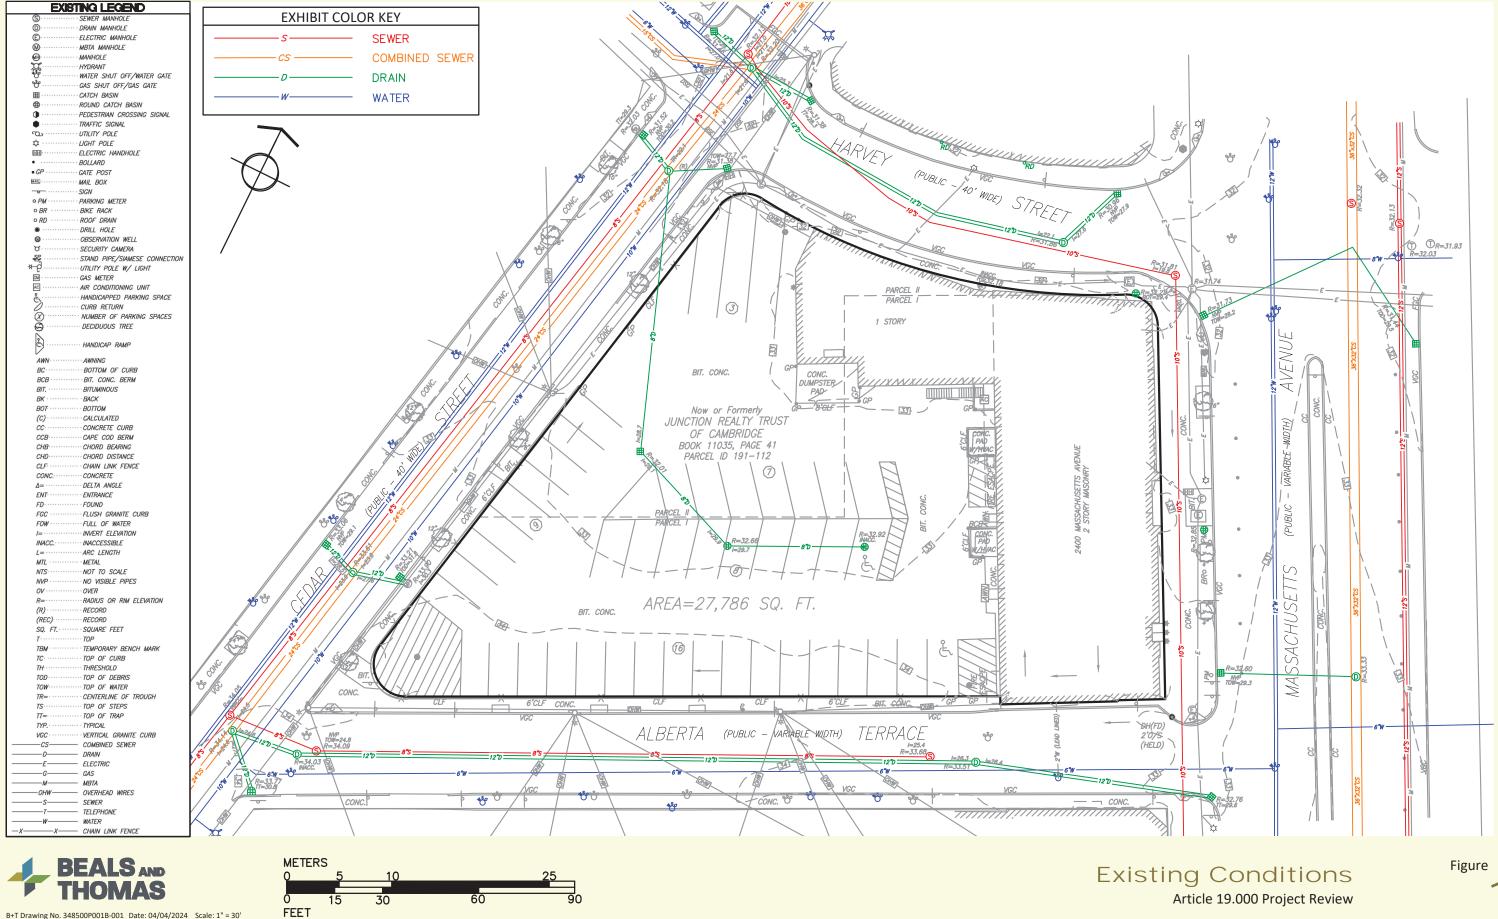1.5 Existing Utilities merge

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Beals and Thomas 1" = 30'-0" 5/31/2024



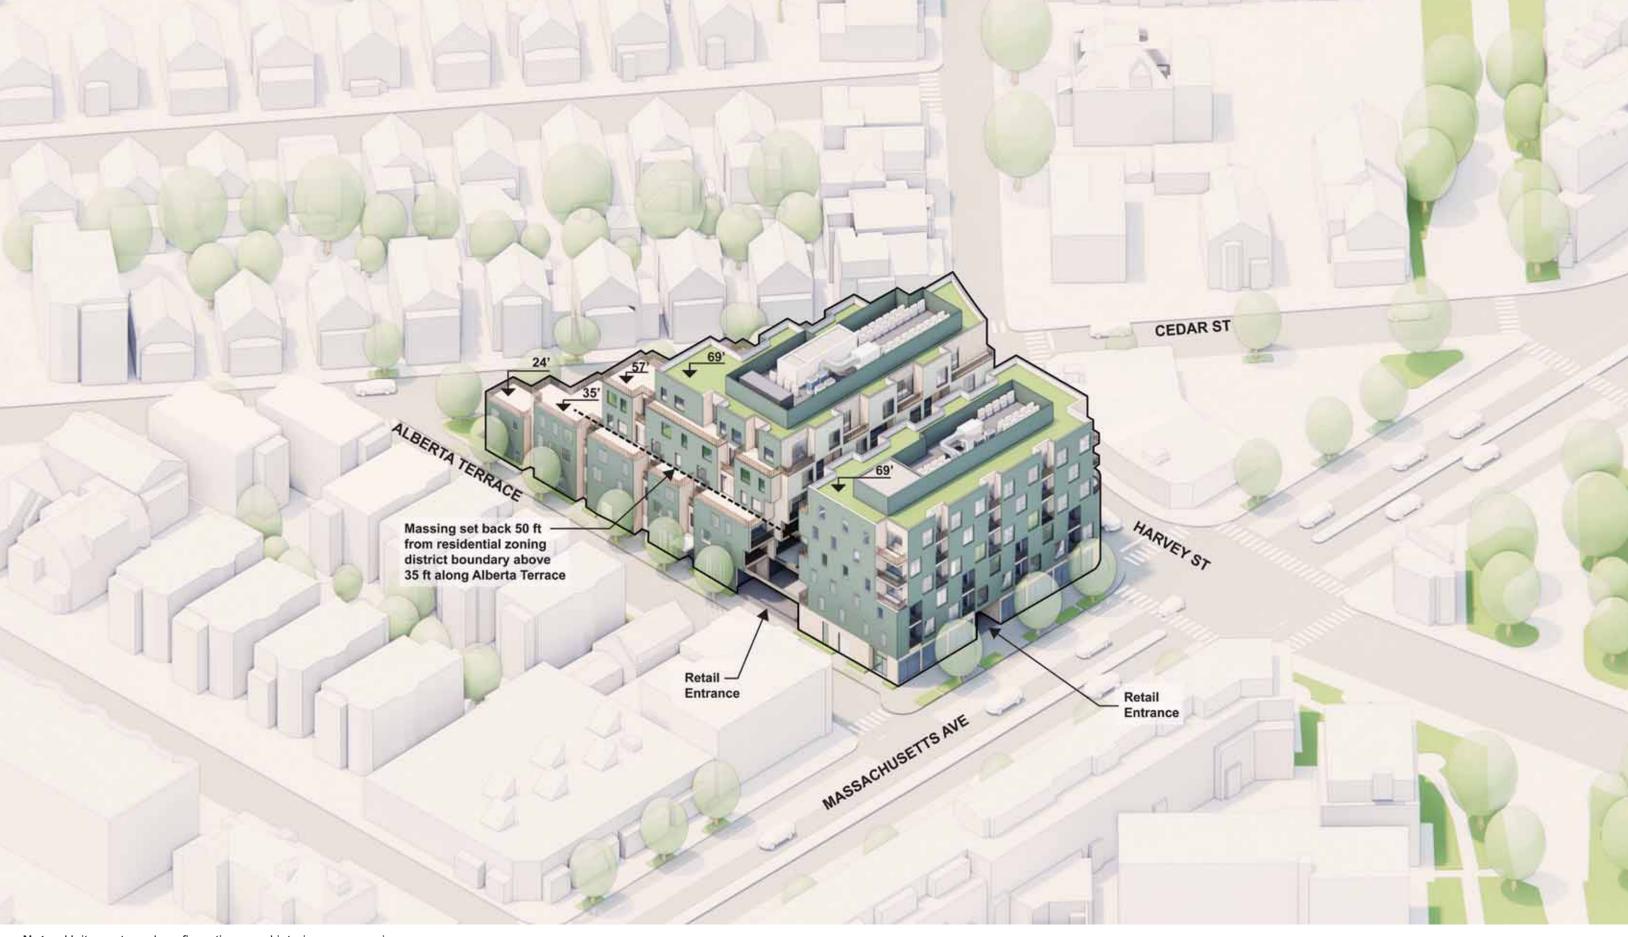

2.1 Massing Diagram

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2.2 Massing Diagram

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Massing set back 50 ft from residential zoning district boundary above 35 ft along Alberta Terrace



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2.3 Proposed Site Plan

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Merge Architects 1" = 40'-0" 5/31/2024



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2.4 Proposed Zoning Setback Plan

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Merge Architects 1" = 40'-0" 5/31/2024



2.5 Landscape Plan

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4 ×

600

30 F1

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Improvements to the public right of way will be coordinated with future city initiatives along the Mass Ave Corridor

Possible space for bike parking to coordinate with future city initiatives along the Mass Ave Corridor









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Note: Unit counts and configurations, and interior programming, are not final and are subject to ongoing review with the City of Cambridge

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2.8 Green Factor Plan

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Landworks





2.9 Green Factor Plan Detail

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Landworks

City of


Cambridge	Cool Score Sheet	Cool Score Sheet	
Project Address		Special Permit Number	Total Lot Area (SF)
2400 Mass Ave			27,785
Applicant Name		Phone Number	Open Space Requirement (%)
			20%
Applicant Contact / Address		Email Address	Zoning District
Project Description			Result
			Pass

Preserved Existing Trees A1 Understory tree currently <10' canopy spread A2 Understory tree currently >10' canopy spread A3 Canopy tree currently <15' canopy spread A4 Canopy tree currently between 15' and 25' canopy spread A5 Canopy tree currently >25' canopy spread A6 New or Transplanted Trees A6 Understory tree A7 Canopy tree B1 Lawn Area	0 0 0 0 0	0.80 1.00 0.80 1.00 1.20 0.60 0.70	+ + + + + + + +	0 0 0 0 14 0	1.60 2.00 1.60 2.00 2.40	
 A2 Understory tree currently >10' canopy spread A3 Canopy tree currently <15' canopy spread A4 Canopy tree currently between 15' and 25' canopy spread A5 Canopy tree currently >25' canopy spread New or Transplanted Trees A6 Understory tree A7 Canopy tree 	0 0 0 0	1.00 0.80 1.00 1.20	+ + + +	0 0 0 0	2.00 1.60 2.00 2.40	
 A3 Canopy tree currently <15' canopy spread A4 Canopy tree currently between 15' and 25' canopy spread A5 Canopy tree currently >25' canopy spread New or Transplanted Trees A6 Understory tree A7 Canopy tree 	0 0 0	0.80 1.00 1.20 0.60	+ + +	0 0 0 14	1.60 2.00 2.40	
 A4 Canopy tree currently between 15' and 25' canopy spread A5 Canopy tree currently >25' canopy spread New or Transplanted Trees A6 Understory tree A7 Canopy tree 	0 0	1.00 1.20 0.60	+ + +	0 0 14	2.40	
 A5 Canopy tree currently >25' canopy spread New or Transplanted Trees A6 Understory tree A7 Canopy tree 	0	1.20	+	0	2.40	
New or Transplanted Trees A6 Understory tree A7 Canopy tree	0	0.60	+	14		
A6 Understory tree A7 Canopy tree					1.20	
A7 Canopy tree					1.20	
	0	0.70	+	0		
31 Lawn Area				0	1.40	
	0	0.30	+	0	0.60	
32 Low Planting Area	0	0.40	+		0.80	
33 High Planting Area	0	0.50	+	218	1.00	
C1 Green Facade	0	0.10	+	0	0.20	
-			+			
			+			
			+	· · · · · · · · · · · · · · · · · · ·		
C5 Intensive Green Roof Area	0	0.60	+	0	1.20	
01 Low Slope Roof	0	N/A				
	2,895	0.1				
03 Shaded Area	1,738	0.2	+	1,002	0.40	
Portion of lot area utilizing green strategies				Total Contribu	Iting Area	
Portion of score from green strategies				Total Area Go	al	
Portion of score from trees 31% Portion of score contributing to public realm cooling 75%				COOL FAC	TOR	
	Low Planting Area High Planting Area I Green Façade Living Wall Green Roof Area Short Intensive Green Roof Area Intensive Green Roof Area I Low Slope Roof High-SRI Paving Shaded Area Portion of lot area utilizing green strategies Portion of score from green strategies 87% Portion of score from trees	2 Low Planting Area 0 3 High Planting Area 0 1 Green Façade 0 2 Living Wall 0 3 Green Roof Area 4,547 4 Short Intensive Green Roof Area 0 5 Intensive Green Roof Area 0 1 Low Slope Roof 0 2 High-SRI Paving 2,895 3 Shaded Area 1,738	2 Low Planting Area 0 0.40 3 High Planting Area 0 0.50 1 Green Façade 0 0.10 2 Living Wall 0 0.30 3 Green Roof Area 4,547 0.30 4 Short Intensive Green Roof Area 0 0.50 5 Intensive Green Roof Area 0 0.50 1 Low Slope Roof 0 N/A 2 High-SRI Paving 2,895 0.1 3 Shaded Area 1,738 0.2 Portion of lot area utilizing green strategies	2 Low Planting Area 0 0.40 + 3 High Planting Area 0 0.50 + 1 Green Façade 0 0.10 + 2 Living Wall 0 0.30 + 3 Green Roof Area 4,547 0.30 + 4 Short Intensive Green Roof Area 0 0.50 + 5 Intensive Green Roof Area 0 0.60 + 1 Low Slope Roof 0 N/A 2,895 0.1 1 Low Slope Roof 0 N/A 2,895 0.1 2 High-SRI Paving 2,895 0.1 + 3 Shaded Area 26% Portion of lot area utilizing green strategies 26% Portion of score from green strategies 87% 87% 87%	2 Low Planting Area 0 0.40 + 1,410 3 High Planting Area 0 0.50 + 218 1 Green Façade 0 0.10 + 0 2 Living Wall 0 0.30 + 0 3 Green Roof Area 4,547 0.30 + 3,122 4 Short Intensive Green Roof Area 0 0.50 + 0 5 Intensive Green Roof Area 0 0.60 + 0 1 Low Slope Roof 0 N/A 2,895 0.1 1 Low Slope Roof 0 N/A 2,895 0.1 2 High-SRI Paving 2,895 0.1 1,738 0.2 + 1,002	2 Low Planting Area 0 0.40 + 1,410 0.80 3 High Planting Area 0 0.50 + 218 1.00 1 Green Façade 0 0.10 + 0 0.20 2 Living Wall 0 0.30 + 0 0.60 3 Green Roof Area 4,547 0.30 + 3,122 0.60 4 Short Intensive Green Roof Area 0 0.50 + 0 1.00 5 Intensive Green Roof Area 0 0.60 + 0 1.20 1 Low Slope Roof 0 N/A 2,895 0.1 1.20 1 Low Slope Roof 0 N/A 2,895 0.1 1.002 0.40 2 High-SRI Paving 2,895 0.1 1.738 0.2 + 1,002 0.40 2 Portion of lot area utilizing green strategies . . 26% Fotal Contributing Area Total Area Goal 2 Portion of score from green strategies . .

2.10 Green Factor Score

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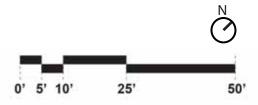
Landworks



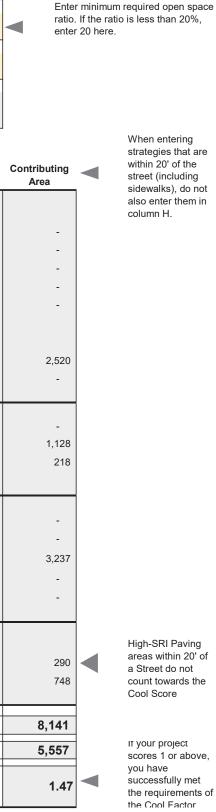

2.11 Parking Level Plan

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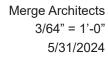






2.13 Second Level Plan

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50'


0' 5' 10'

25'



2.14 Third Level Plan

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2.15 Fourth Level Plan
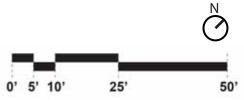
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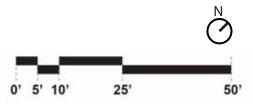







2.16 Fifth Level Plan

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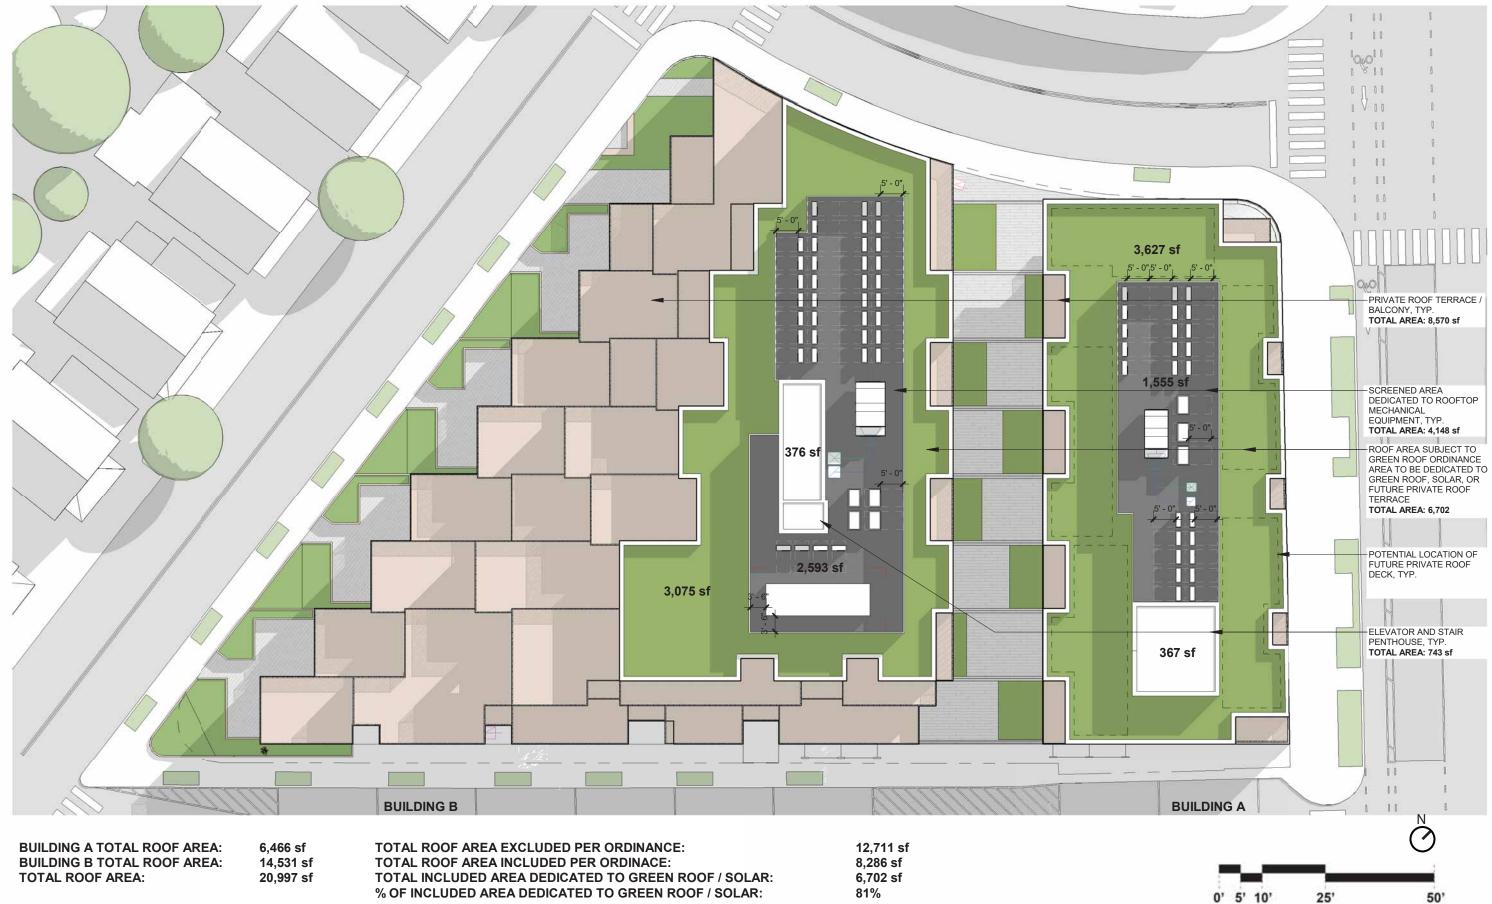




2.17 Sixth Level Plan
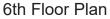
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2.18 Roof Plan and Green Roof Layout

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ALBERTA TERRACE

-ENTRANCE INTO RETAIL CORRIDOR

MASSACHUSETTS AVE ELEVATION



CEDAR STREET ELEVATION

Note: Unit counts and configurations, and interior programming, are not final and are subject to ongoing review with the City of Cambridge

2.19 Building Elevations

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-HARVEY STREET


-ALBERTA TERRACE



2.20 Building Elevations 2400 Massachusetts Ave | North Cambridge Partners LLC | Article 19 Graphic Volume



2.21 Building Elevations e 2400 Massachusetts Ave | North Cambridge Partners LLC | Article 19 Graphic Volume

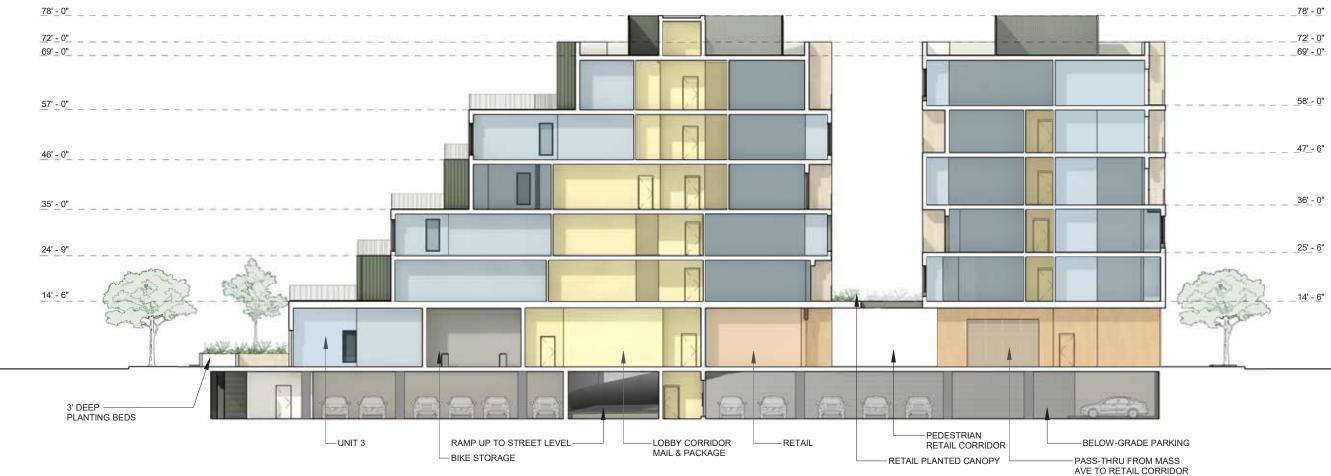

BUILDING SECTION

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2.22 Building Section

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Summer Solstice 9-00 AM

Summer Solstice 12-00 PM

Summer Solstice 4-00 PM

Note: Unit counts and configurations, and interior programming, are not final and are subject to ongoing review with the City of Cambridge



2.23 Shadow Studies

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Spring-Fall Equinox 9-00 AM

Spring-Fall Equinox 12-00 PM

Spring-Fall Equinox 4-00 PM

Note: Unit counts and configurations, and interior programming, are not final and are subject to ongoing review with the City of Cambridge



2.24 Shadow Studies

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Winter Solstice 9-00 AM

Winter Solstice 12-00 PM

Winter Solstice 4-00 PM

Note: Unit counts and configurations, and interior programming, are not final and are subject to ongoing review with the City of Cambridge




2.25 Shadow Studies

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Cambridge, Massachusetts



B+T Drawing No. 348500P001B-001 Date: 04/04/2024 Scale: 1" = 30'

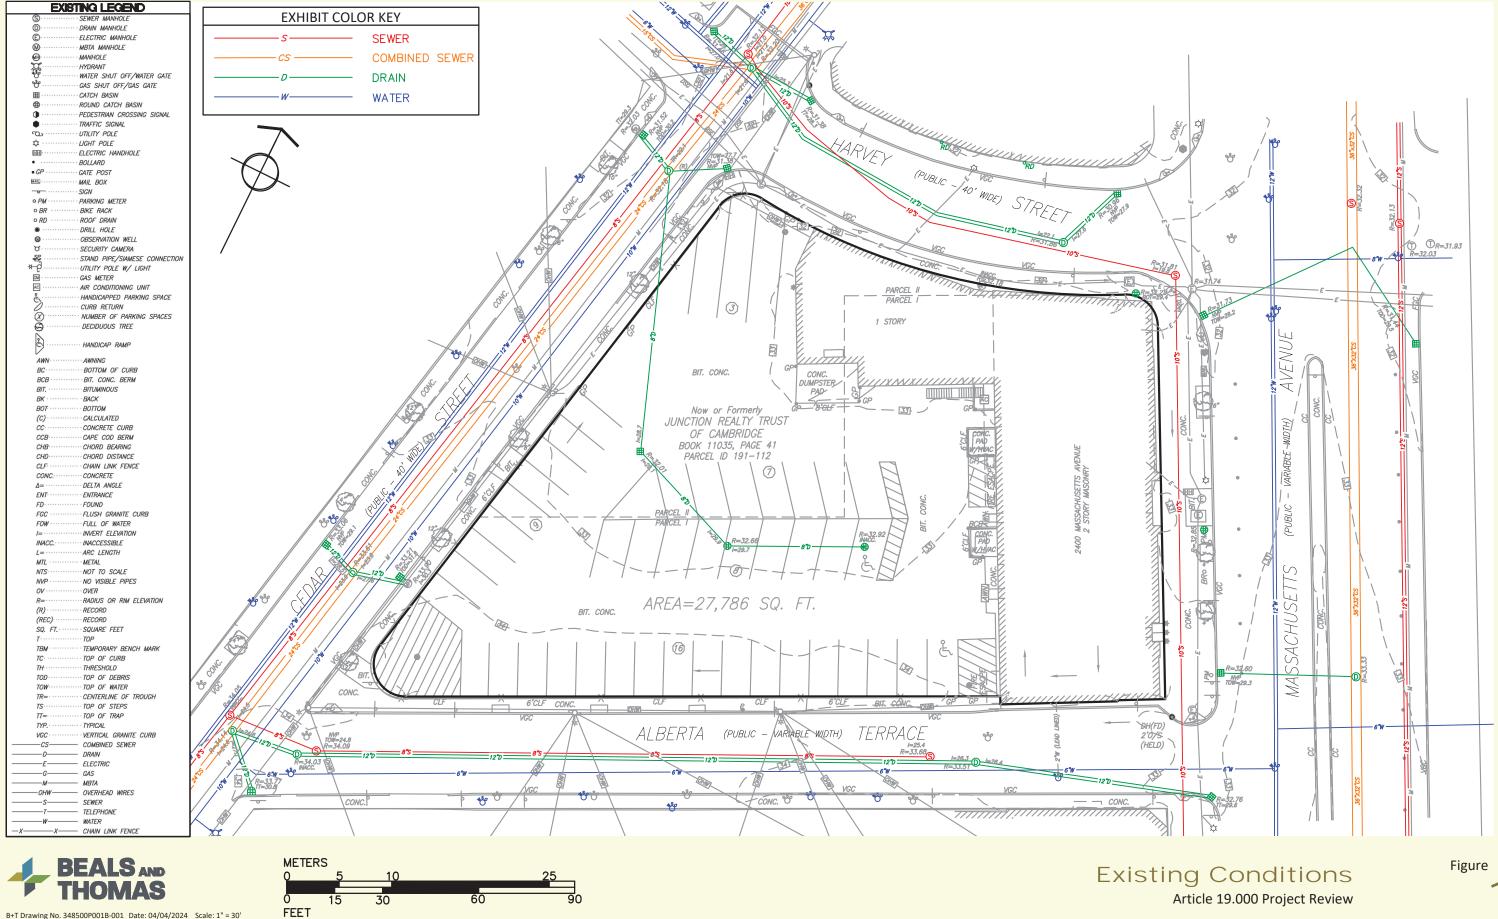merge

2.26 Proposed Utilities

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Beals and Thomas 1" = 30'-0" 5/31/2024



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3.1 Vehicular Circulation

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Merge Architects 1" = 40'-0" 5/31/2024



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3.2 Bicycle Circulation

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Merge Architects 1" = 40'-0" 5/31/2024




SITE PLAN

LONG TERM PARKING PLAN

Note: Unit counts and configurations, and interior programming, are not final and are subject to ongoing review with the City of Cambridge



INVERTED U BIKE RACK TYP.

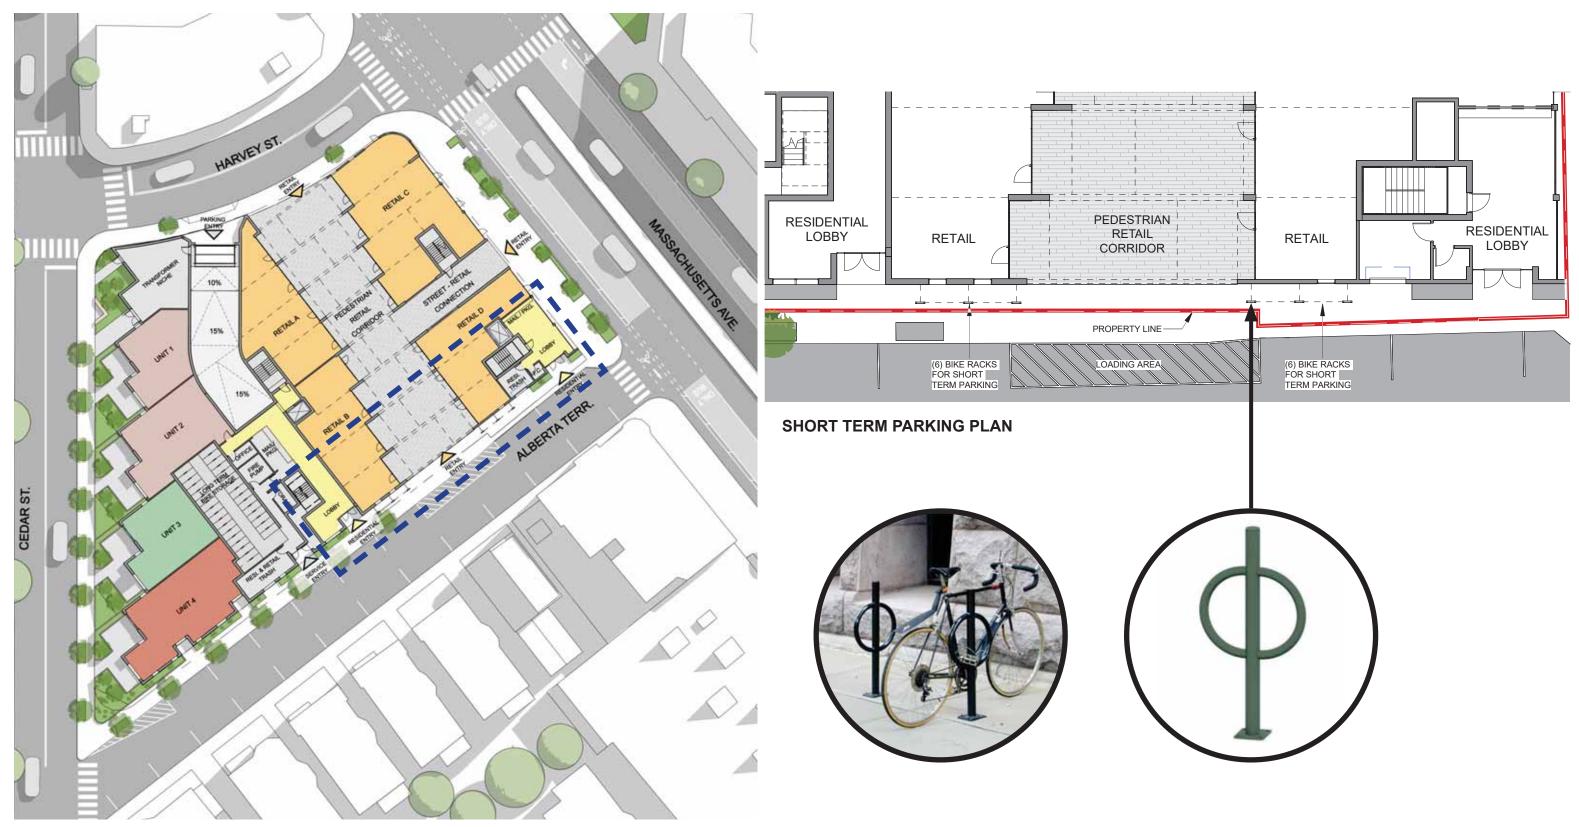

SITE PLAN

STANDARD BOLLARD BIKE RACK TYP.

Note: Unit counts and configurations, and interior programming, are not final and are subject to ongoing review with the City of Cambridge





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3.5 Site Loading Circulation

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4.1 View From Cedar St2400 Massachusetts Ave | North Cambridge Partners LLC | Article 19 Graphic Volume





4.2 View From Alberta Terrace

2400 Massachusetts Ave | North Cambridge Partners LLC | Article 19 Graphic Volume





4.3 View From Massachusetts Ave 2400 Massachusetts Ave | North Cambridge Partners LLC | Article 19 Graphic Volume





4.4 View From Harvey St

2400 Massachusetts Ave | North Cambridge Partners LLC | Article 19 Graphic Volume



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4.5 View From Pedestrian Retail Corridor 2400 Massachusetts Ave | North Cambridge Partners LLC | Article 19 Graphic Volume



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4.6 View Of Pedestrian Retail Corridor From Dwelling Unit 2400 Massachusetts Ave | North Cambridge Partners LLC | Article 19 Graphic Volume





Aluminum Storefront Systems Finished Black Frames Storefront glass to be low-iron with at least 70% VLT and VLR no higher than 15%, and will follow bird-safe best practices Located at ground floor retail

Note: Unit counts and configurations, and interior programming, are not final and are subject to ongoing review with the City of Cambridge



4.7 Color and Material Palette

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Corrugated Metal Panels Box Rib Wall Panel Systems With Varied Profiles Forest Green Finish 2" Wide / 1-3/8" Depth

Metal Railings Forest Green Finish





Wood-look Cladding 8" Wide





Perforated Corrugated Metal Panels Box Rib Wall Panel Systems With Varied Profiles Forest Green Finish 2" Wide / 1-3/8" Depth

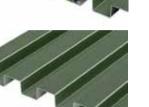

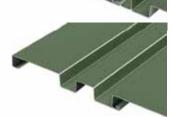



Merge Architects







Wood-look Cladding 8" Wide

Black Aluminum Window Frames Windows to be at least 70% VLT with VLR no higher than 15%, and will follow bird-safe best practices



4.8 Color and Material Palette

2400 Massachusetts Ave | North Cambridge Partners LLC | Article 19 Graphic Volume



Corrugated Metal Panels Box Rib Wall Panel Systems With Varied Profiles Light Green Finish 2" Wide / 1-3/8" Depth



Steel Support Structure Light Green Finish



Planted Canopy Roofs

Metal Railings Light Green

Merge Architects