12/1/22, 11:27 AM

CITY OF CAMBRIDGE BOARD OF ZONING APPEAL

831 Massachusetts Avenue, Cambridge MA 02139 2022 DEC -7 PM 12: 17

about:blank

617-349-6100

OFFICE OF THE CITY CLERK CAMBRIDGE, MASSACHUSETTS

BZA Application Form

General Information

The undersigned hereby petitions the Board of Zoning Appeal for the following:

Special Permit: X____X

Variance: _____

PETITIONER: Talaya Delaney & Niall Stephens C/O Morse Constructions

PETITIONER'S ADDRESS: 166 Vassal Lane, Cambridge, MA 02138

LOCATION OF PROPERTY: 164-166 VASSAL LN, Unit 166, Cambridge, MA

TYPE OF OCCUPANCY: Two Family

ZONING DISTRICT: Residence B Zone

Appeal: _____

REASON FOR PETITION:

/Additions/

DESCRIPTION OF PETITIONER'S PROPOSAL:

The petitioner proposes alterations to an existing non conforming two family dwelling. Relief is required for a new third floor addition that falls within the side and rear setbacks as well as increasing the non conforming gross floor area.

SECTIONS OF ZONING ORDINANCE CITED:

- Article: 5.000 Section: 5.31 (Table of Dimensional Requirements).
- Article: 8.000 Section: 8.22.2.d (Non-Conforming Structure).
- Article: 10.000 Section: Section 10.40 (Special Permit)

Original Signature(s):

titioner (s) / Owner) (Print Name

Address: Tel. No. E-Mail Address:

617-308-6651 niall.stephens@gmail.com



BZA Number: 202716

BZA APPLICATION FORM - OWNERSHIP INFORMATION

To be completed by OWNER, signed before a notary and returned to The Secretary of the Board of Zoning Appeals.

I/We	Niall Stephens & Talaya Delaney
	(OWNER)
Address:	166 Vassal Ln, Cambridge, MA 02138
State that I	/We own the property located at 164-166 Vassal Ln, Unit 166, Cambridge, MA,02138
which is the	subject of this zoning application.
The record t	itle of this property is in the name of
	Niall Stephens & Talaya Delaney
*Pursuant to	a deed of duly recorded in the date <u>May 17,2019</u> , Middlesex South
County Regis	try of Deeds at Book, Page, Page; or
Middlesex Re	gistry District of Land Court, Certificate No
Book	Page
	SIGNATURE BY LAND OWNER OR AUTHORIZED TRUSTEE, OFFICER OR AGENT*
*Written evi	dence of Agent's standing to represent petitioner may be requested.
Commonwealth	of Massachusetts, County of Middlesex
The above-na	me Niall P Stephens and Talaya A personally appeared before me,
this 15th o	f Wovember, 20 22, and made oath that the above statement is true.
	n expires August 1, 2025 (Notary Seal) The Commonwealth of Massachuse

• If ownership is not shown in recorded deed, e.g. if by court order, recent deed, or inheritance, please include documentation.

BZA Application Form

SUPPORTING STATEMENT FOR A SPECIAL PERMIT

Please describe in complete detail how you meet each of the following criteria referring to the property and proposed changes or uses which are requested in your application. Attach sheets with additional information for special permits which have additional criteria, e.g.; fast food permits, comprehensive permits, etc., which must be met.

Granting the Special Permit requested for <u>164-166 VASSAL LN , Unit 166 , Cambridge, MA</u> (location) would not be a detriment to the public interest because:

A) Requirements of the Ordinance can or will be met for the following reasons:

Per Article 8.22.2(d) as well as the Mass General Laws Chapter 40a section6, existing nonconforming one and two family structures shall be granted special permit in finding that the alterations or englargement shall not be substantially more detrimental than the non-conforming structure to the neighborhood. The existing two family structure does not presently comply with the right side yard setback, the rear yard setback, and the allowable Floor Area Ratio. The proposed expansion and renovation will not increase any other nonconformities.

B) Traffic generated or patterns of access or egress would not cause congestion hazard, or substantial change in established neighborhood character for the following reasons:

The proposed addition and alterations will not cause a change in traffic patterns in the neighborhood. The existing house has two dwelling units, and the proposed renovation will also contain two dwelling units and therefore access to and from the property will not create a substantial change to the neighborhood.

The continued operation of or the development of adjacent uses as permitted in the Zoning
Ordinance would not be adversely affected by the nature of the proposed use for the following reasons:

The proposed alterations and additions to the residential structure have been aesthetically designed to meet the characteristics of the neighborhood. The addition will be very similar to an approved and completed project just next door. The proposed increase in size and volume of the house occurs vertically up to the allowable height for the zoning district and therefore not an impediment to adjacent development.

D) Nuisance or hazard would not be created to the detriment of the health, safety, and/or welfare of the occupant of the proposed use or the citizens of the City for the following reasons:

The proposed alterations will be constructed in accordance with all the requirements of the State Building Code and will not cause nuisance or hazards.

E) For other reasons, the proposed use would not impair the integrity of the district or adjoining district or otherwise derogate from the intent or purpose of this ordinance for the following reasons:

The proposed work on the two family dwelling is consistent with work that is in the neighborhood as well as the larger district. The use is remaining the same and fits within the district.

2

×

about:blank

BZA Application Form

DIMENSIONAL INFORMATION

Applicant:	Talaya Delaney & Niall Stephens			
Location:	164-166 VASSAL LN , Unit 166 , Cambridge, MA			
Phone:	617-308-6651			

Present Use/Occupancy: Two Family

Zone: Residence B Zone

Requested Use/Occupancy: Two Family

		Existing Conditions	<u>Requested</u> <u>Conditions</u>	<u>Ordinance</u> <u>Requirements</u>	
TOTAL GROSS FLOOR AREA:		2160	2660	1953	(max.)
LOT AREA:		3906	3906	5000	(min.)
RATIO OF GROSS FLOOR AREA TO LOT AREA: ²		.55	.68	.5	
LOT AREA OF EACH DWELLING UNIT		1953	1953	2500	
<u>SIZE OF LOT:</u>	WIDTH	50	50	50	
	DEPTH	94.74	94.74	100	
SETBACKS IN FEET:	FRONT	8	8	15	
	REAR	20.1	20.1	25	
	LEFT SIDE	21.1	21.1	7.5	
	RIGHT SIDE	5.1	5.1	7.5	
SIZE OF BUILDING:	HEIGHT	29.2	34.8	35	
	WIDTH	41.5	41.5	N/A	
	LENGTH	24.7	24.7	N/A	
RATIO OF USABLE OPEN SPACE TO LOT AREA:		60	60	40	
<u>NO. OF DWELLING</u> <u>UNITS:</u>		2	2	1	
NO. OF PARKING SPACES:		N/A	N/A	N/A	
NO. OF LOADING AREAS:		N/A	N/A	N/A	
DISTANCE TO NEAREST BLDG. ON SAME LOT		N/A	N/A	N/A	

Describe where applicable, other occupancies on the same lot, the size of adjacent buildings on same lot, and type of construction proposed, e.g; wood frame, concrete, brick, steel, etc.:

N/A

- 1. SEE CAMBRIDGE ZONING ORDINANCE ARTICLE 5.000, SECTION 5.30 (DISTRICT OF DIMENSIONAL REGULATIONS).
- 2. TOTAL GROSS FLOOR AREA (INCLUDING BASEMENT 7'-0" IN HEIGHT AND ATTIC AREAS GREATER THAN 5') DIVIDED BY LOT AREA.
- 3. OPEN SPACE SHALL NOT INCLUDE PARKING AREAS, WALKWAYS OR DRIVEWAYS AND SHALL HAVE A MINIMUM DIMENSION OF 15'.

DELANEY-STEPHENS RENOVATION 166 VASSAL LANE CAMBRIDGE, MA



PROJECT NARRATIVE

RENOVATION OF THE TOP UNIT OF A TWO FAMILY DWELLING. THE RENOVATION WORK INCLUDE ADDING TWO NEW BEDROOMS AND A BATH TO A NEW THIRD FLOOR. A NEW STAIR TO ACCESS THE SPACE WILL ALSO BE ADDED FROM THE SECOND TO THIRD FLOOR.

CLIENT DELANEY-STEPHENS

166 VASSAL LANE CAMBRIDGE, MA **DESIGNER / GENERAL CONTRACTOR**




SPECIAL PERMIT 11/11/2022

SHEET LIST

G100	COVER
G101	NOTES
A100	SECOND FLOOR PLAN
A101	THIRD FLOOR PLAN
A200	ELEVATIONS
A900	3-D VIEWS
A102	PHOTOS

LOCATION PLAN

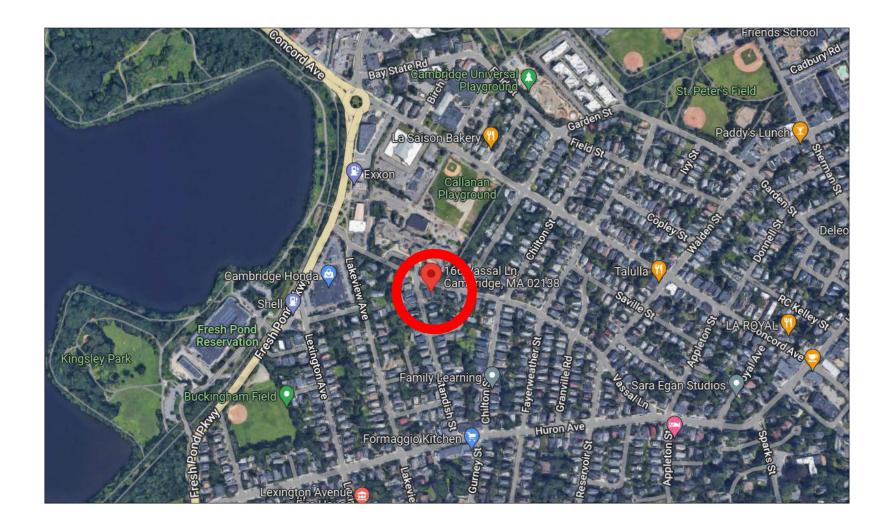

DRAWINGS AND SPECIFICATIONS ARE INTENDED TO PROVIDE THE BASIS FOR TH PROPER COMPLETION OF THE PROJECT SUITABLE FOR THE INTENDED USE OF OWNER. ITEMS NOT EXPRESSLY SET FORTH BUT WHICH ARE REASONABLY IMPL OR NECESSARY FOR THE PROPER PERFORMANCE OF THIS WORK SHALL BE INCLUDED.

COMPLY WITH APPLICABLE CODES, REGULATIONS, ORDINANCES AND REQUIREMENTS OF AUTHORITIES HAVING JURISDICTION, INCLUDING ACCESSIBILITY GUIDELINES WHERE APPLICABLE. SUBMIT COPIES OF INSPECTIO REPORTS, NOTICES AND SIMILAR DOCUMENTS TO ARCHITECT. PLANS ARE BASE ON MASSACHUSETTS RESIDENTIAL BUILDING CODE 9th EDITION & CURRENT MA (2006 EDITION).

THE CONTRACTOR, SUBCONTRACTORS, AND MATERIAL SUPPLIERS SHALL REFE TO THE DRAWINGS, SCHEDULES AND SPECIFICATIONS AS A WHOLE WHEN DETERMINING THE CONSTRUCTION REQUIREMENTS FOR THE PROJECT.

PROVIDE PRODUCTS AND MATERIALS SPECIFIED. REQUEST OWNER'S/ ARCHITECT'S SELECTION OF COLORS AND ACCESSORIES IN SUFFICIENT TIME TO AVOID DELAYING PROGRESS OF THE WORK.

THE CONTRACTOR IS RESPONSIBLE FOR IDENTIFYING ALL AREAS ON THE PROJEC WHICH REQUIRE TOLERANCES BETWEEN ROUGH OPENINGS AND/OR FINISH MATERIALS AND PROVIDE FOR THE PROPER TOLERANCES TO COMPLETE THE CONSTRUCTION IN ACCORDANCE WITH THE REQUIREMENTS OF THE CONTRACT DOCUMENTS.

ALL DRAWINGS, SCHEDULES AND SPECIFICATIONS IN THE BID PACKAGE ARE TO CONSIDERED EQUAL PARTS OF THIS CONTRACT PACKAGE. THE CONTRACTOR A SUBCONTRACTORS SHALL BE RESPONSIBLE FOR THE REVIEW AND COORDINAT OF ALL DRAWINGS, SCHEDULES AND SPECIFICATIONS. ALL DISCREPANCIES OMISSIONS OR ERRORS THAT OCCUR SHALL BE BROUGHT TO THE ATTENTION (THE ARCHITECT IN WRITING PRIOR TO THE SUBMISSION OF BIDS SO THAT CLARIFICATION MAY BE ISSUED.

ANY WORK PERFORMED IN CONFLICT WITH ANY PART OF THE CONTRACT DOCUMENTS OR ANY CODE REQUIREMENT SHALL BE CORRECTED BY THE CONTRACTOR AT THEIR OWN EXPENSE AND AT NO EXPENSE TO THE OWNER OR ARCHITECT.

THE CONTRACTOR AND SUBCONTRACTORS SHALL BE RESPONSIBLE FOR COORDINATION OF THEIR WORK WITH THE WORK OF OTHER TRADES. SUBCONTRACTORS SHALL VERIFY THAT ANY WORK RELATED TO THEM, WHICH MUST BE PROVIDED BY OTHERS HAS BEEN COMPLETED AND IS ADEQUATE PRIC TO COMMENCING THEIR WORK.

ALL DIMENSIONS SHALL TAKE PRECEDENCE OVER SCALE SHOWN ON PLANS. SECTIONS AND DETAILS. DIMENSIONS ARE TO FACE OF FINISH UNLESS NOTED OTHERWISE ON DRAWINGS. DO NOT SCALE DRAWINGS. NOTIFY THE ARCHITECT/ENGINEER OF ANY DISCREPANCIES AND DO NOT PROCEED WITHOU INSTRUCTIONS/CLARIFICATION.

THE CONTRACTOR SHALL VERIFY ALL CONDITIONS AND DIMENSIONS AND REPORT ANY DISCREPANCIES TO THE ARCHITECT/ENGINEER.

VERIFY ALL SITE CONDITIONS PRIOR TO COMMENCING CONSTRUCTION.

THE CONTRACTOR SHALL BE SOLELY RESPONSIBLE FOR JOB SITE SAFETY OF IT EMPLOYEES AND OTHER PERSONS IN THE CONSTRUCTION AREA, AS WELL AS F THE PROTECTION OF THE SAFETY OF THE IMPROVEMENTS BEING ERECTED AND THE PROPERTY OF THE CONTRACTOR AND/OR OTHER PERSONS, AS A RESULT **OPERATIONS HEREUNDER.**

THE CONTRACTOR SHALL BE FULLY AND COMPLETELY LIABLE AT HIS OWN EXPENSE FOR DESIGN, CONSTRUCTION, INSTALLATION AND USE OR NON-USE (ALL ITEMS AND METHODS INCIDENT TO PERFORMANCE OF EITHER PERSON OR PROPERTY, INCLUDING WITHOUT LIMITATION THE ADEQUACY OF ALL TEMPORAL SUPPORTS, SHORING, BRACING, SCAFFOLDING, MACHINERY OR EQUIPMENT, SAFETY PRECAUTIONS OR DEVICES, AND SIMILAR ITEMS OR DEVICES USED DURING CONSTRUCTION.

THE CONTRACTOR SHALL FURNISH ALL MATERIALS, LABOR, AND EQUIPMENT NECESSARY TO PROPERLY COMPLETE THE WORK, INCLUDING ITEMS NOT SPECIFICALLY SET FORTH IN THE CONSTRUCTION DOCUMENTS BUT REASONAB INFERRED.

THE CONTRACTOR SHALL COORDINATE ALL WORK WITH THE OWNER OR WITH T OWNER'S REPRESENTATIVE. THE CONTRACTOR SHALL OBTAIN AND BE RESPONSIBLE FOR ALL FEES, PERMITS, AND INSPECTIONS REQUIRED AND ASSOCIATED WITH ALL PHASES OF THE WORK.

ALL ITEMS TO BE REMOVED SHALL BECOME PROPERTY OF THE CONTRACTOR AN SHALL BE REMOVED ENTIRELY FROM THE PROJECT SITE, UNLESS NOTED OTHERWISE. RETURN ITEMS IDENTIFIED FOR SALVAGE OR REUSE TO THE OWNER/PROPERTY MANAGER.

THE DRAWINGS ARE NOT INTENDED FOR USE AS SHOP OR ERECTION DRAWINGS. CONTRACTOR TO PHASE ALL WORK SUCH THAT THE OCCUPIED PORTIONS OF THE

CONTRACTOR TO PROVIDE TEMPORARY BARRIERS AT ALL FLOOR PENETRATIONS PREVENT PHYSICAL BODILY DAMAGE.

BUILDING ARE SAFE & AVAILABLE THROUGHOUT CONSTRUCTION.

CONTRACTOR TO PROVIDE A CLEAN JOB SITE FREE FROM DEBRIS THROUGHOUT CONSTRUCTION AT ALL FLOORS.

CONTRACTOR REQUIRED TO LOCATE ALL STRUCTURAL, MECHANICAL, ELECTRICAL, PLUMBING & FIRE PROTECTION COMPONENTS AND CLEAR SPACE PRIOR TO WORK.

VERIFY STAGING AREA, PARKING AVAILABILITY, AND RULES FOR USE WITH PROPERTY OWNER.

MAINTAIN PROPER EMERGENCY EGRESS AND FIRE ALARM SYSTEMS THROUGHOUT DEMOLITION AND RENOVATION.

PROTECT EXISTING FINISHES, COMPONENTS, & STRUCTURE NOT SCHEDULED FOR RENOVATION, REMOVAL, OR ALTERATION. REPAIR AND SUCH MATERIALS, FINISHES, OR COMPONENTS DAMAGED DURING EXECUTION OF THIS PROJECT.

PATCH, PREP AND PAINT ALL WALLS THROUGHOUT WORK AREA.

VERIFY & PROTECT EXISTING SUBSURFACE, SURFACE, VISIBLE, & HIDDEN UTILITIES THROUGHOUT DEMO & RENOVATION AREAS. KEY ALL NEW LOCKS TO BUILDING STANDARD MASTER KEY SYSTEM; VERIFY W/ OWNER

HE	GENERAL
THE	1. Structural work shall conform to the requirements of "The
_IED	Commonwealth of Massachusetts State Building Code". 9th Edition.
	(One and Two Family Dwelling Code), "The International Residential
	Code", IRC2015, and ASCE 7-10.
	2. Examine architectural, mechanical, plumbing and electrical drawings for
	verification of location and dimensions of chases, inserts, openings,
	sleeves, washes, drips, reveals, depressions and other project
N	requirements not shown on structural drawings.
ED	3. Verify and coordinate dimensions related to this project.
AB	4. Typical details and notes shown on structural drawings shall be
	applicable to all parts of the structural work except where specifically
	required otherwise by contract documents.
ER	required otherwise by contract documents.
_1\	
	FOUNDATIONS 1. Foundations for this project consist of a new slab. The allowable
	bearing pressure is assumed to be 2.0 tons per square foot. The
0	contractor is to verify suitability of soils and notify the
0	Architect/Engineer if conditions are not as assumed.
	2. No responsibility is assumed by the architect/engineer for the validity
-	of the subsurface conditions described on the drawings, specifications,
Т	test borings or test pits. These data are included only to assist the
	contractor during bidding and subsequent construction and represent
	conditions only at these specific locations at the particular time they
	were made.
	3. Foundation units shall be centered under supported structural
	members, unless noted otherwise on the drawings.
) BE	4. Carry out continuous control of surface and subsurface water during
AND	construction such that foundation work is done in dry and on
ION	undisturbed subgrade material as applicable.
OF	<u>CONCRETE</u>
	1. Concrete work shall conform to "Building Code Requirements for
	Reinforced Concrete" (ACI 318-14), and "Specifications for Structural
	Concrete for Buildings" (ACI 301-14).
	2. Unless noted otherwise, concrete shall have a minimum 28 day
	compressive strength of 4,000 psi normalweight.
	3. Concrete to be exposed to the weather in the finished project shall
	be air.
	STRUCTURAL TIMPER CONSTRUCTION
	<u>STRUCTURAL TIMBER CONSTRUCTION</u> 1. Timber construction shall conform to Part II "Design" as published in
)R	the "Timber Construction Manual" (AITC 6th Edition) and to "National
	Design Specification for Wood Construction" (N.F.P.A. 2012 Edition)
	2. New timber for structural use shall have a moisture content as
	specified in the "National Design Specification for Wood Construction
	(N.F.P.A. 2012 Edition).
	3. Timber construction shall conform to Article 23 of IBC 2015.
· T	4. Material properties for timber shall conform to the following:
JT	(A) For members with nominal 2" thickness. S-P-F #1/#2 or better
	(15% max_MC).
_	Allowable bending stress:
-	Fb = 875 PSI (single member use)
	Fb = 1000 PSI (multiple member use) Allowable shear stress Fv =
	135 PSI Compression parallel to grain = 1100 PSI Compression
	perpendicular to grain = 425 PSI Modulus of elasticity - 1,400.000
	PSÍ
ГS	(B) For pressure-treated members with nominal 2" thickness, Southern
FOR	Pine #1 or better (19% max MC).
D	Allowable bending stress Fb = 1300 PSI Allowable shear stress Fv =
OF	90 PSI Compression parallel to grain = 1550 PSI Compression
	perpendicular to grain = 565 PSI Modulus of elasticity = 1,500,000
	PSI
	(C) For pressure-treated members with nominal 4" thickness and greater,
DF	Southern Pine #2 pressure-treated (19% max MC).
	Allowable bending stress Fb = 1250 PSI Allowable shear stress Fv =
RY	95 PSI Compression parallel to grain = 725 PSI Compression
	perpendicular to grain = 440 PSI Modulus of elasticity = 1,400,000
	PSI
	5. "PT" indicates pressure-treated lumber (to be used when in contact
	with concrete, masonry or weather).
	6. Joist support by nailing is forbidden unless used with an approved
	hanger. Unless noted otherwise on plans, all flush framed joists and
BLY	beams shall framed with Simpson hangers as follows (or approved
	equals):
	(A) 2x6; 2x8 Type 'U26'
THE	(A) 2x6, 2x6 (B) 2-2x6; 2-2x8 Type 'U26-2'
··· ·	
	(E) 2-2x10; 2-2x12 Type 'U210-2' (F) 3-2x10; 3-2x12 Type 'U210-3'
ND	
	(G) 3-1/2" x 9-1/4" LVL Type 'GLTV3.56/9.25'
	(H) 5-1/4" x 9-1/4" LVL Type 'GLTV5.550/9.25'
	(It is the contractor's responsibility to determine correct hangers for all sloped
	and/or skewed conditions. Custom hangers may be required at ridge/valley
	connections-submit to engineer for review.)
:	
T 0	
то	

7.	Minimum	bearing	for	all je	oists	and	rafters	shall	be	4".	
3	Use doub	ole ioists	und	ler a	all pa	rtitio	ns				

Interior walls indicated on plans shall be framed with 2x4's at 16" O.C. (see arch drawings).

New exterior walls indicated on plans shall be framed with 2x6's at 16" O.C. with 1/2" plywood sheathing nailed to studs with 10d nails at 4" O.C. at panel edges and 12" O.C. in field. 11. Interior door headers shall be a minimum of 2-2x8's unless noted otherwise on the plans.

Exterior door and window headers shall be a minimum of 2-2x10's 12. unless noted otherwise on the plans.

13. No joist shall be notched or drilled with holes without the specific approval of the architect.

No joist shall be repaired or reinforced in any way without the 14 specific approval of the architect.

Beams built up of timbers shall be firmly nailed or bolted together. 16. Plywood shall be laid with face grain parallel to span; stagger all

17. Temporary erection bracing shall be provided to hold structural timber securely in position as described on the drawings. It shall not be removed until permanent bracing has been installed. 18. Timber shall be generally knot-free, with only small tight knots

permitted and generally straight-grained. 19. Structural timber shall be identified by the grade mark of or

certificate of inspection issued by a grading or inspection bureau or agency recognized as being competent. 20. Structural timber shall be visually stress-graded lumber in accordance with the provisions of ASTM designation D245-74, "Methods for Establishing Structural Grades and Related Allowable Properties for

Visually Graded Lumber". 21. Timber shall be so handled and covered as to prevent marring and moisture absorption from snow and rain. Steel plates and angles shall be new steel conforming to ASTM 22.

RENOVATION AND RESTORATION

A36.

The contractor shall notify the architect when, in the course of construction of demolition, conditions are uncovered which are unanticipated or otherwise appear to present a dangerous condition.

Information regarding existing construction or conditions is based on available record drawings which may or may not truly reflect existing conditions. Such information is included on assumption that it may be of interest to the contractor, but the architect assumes no responsibility for its accuracy or completeness.

3. Verify all dimensions and conditions on the job. Discrepancies shall be brought immediately to the attention of the architect before proceeding with that part of the work. Where new work will be adjacent to or framing existing construction,

4. verify dimensions of existing construction prior to fabrication of new members.

Provide all labor and material for any framing required to connect new framing to existing construction. Wherever it is necessary to remove existing construction in order to construct new work, the affected area shall be patched and rebuilt to match existing adjacent work to satisfaction of the architect. 6. Details shown on any drawings shall be considered typical for all

similar conditions. Notify architect of any contemplated structural alteration in

reasonable time to render and document the architect's decision. Structural materials and components shall have prior approval of the 8. architect.

9. Structural alteration shall be preceded by adequate shoring and bracing. 10. Screw-type shoring posts shall be provided for existing work during the removal of existing bearing walls and structural members and the

installation of new structural work. Temporary shores shall be placed as close as practicable to the 11.

existing structural work being removed. 12. Headers shall be placed across top of shoring posts and shall be snug tight against underside of the structure above.

Shoring shall bear on sleepers to prevent damage to the structural 13. below

Temporary shores shall be individually designed, erected, supported, 14. braced and maintained by the contractor to safely support all dead loads presently carried by the existing structural work being removed

and any construction live loads. 15. Structural steel shall be completely installed before removing any shores

Shores shall be released gradually and left loosely in place for at 16. least 2 days to allow for structural shake out.

STRUCTURAL DESIGN LOADS Dead loads

(A) Weight of building components


Live Loads (A) Typical Residential Floor - 40 PSF


(B) Roof snow load - 45 PSF plus drift Pg = 40 PSF; Is = 1.0; Ce = 1.0; Ct = 1.0;

3. Wind loads - Per Mass. Code and ASCE7-10

MATERIALS KEY




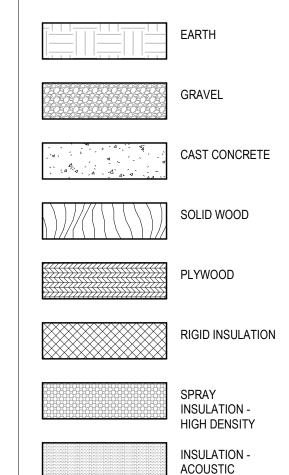

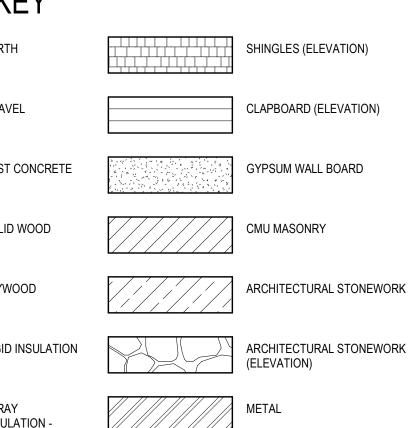



SYMBOLS

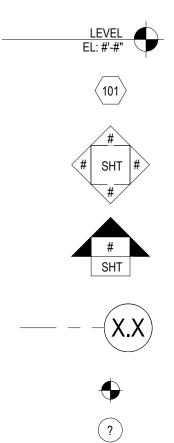

ELEVATION MARKER DOOR REFERENCE NUMBER


INTERIOR ELEVATION REFERENCE

EXTERIOR ELEVATION REFERENCE

STRUCTURAL GRID LINE

ELEVATION CALL OUT

KEYNOTE REFERENCE

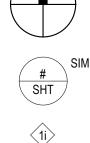

(M-01)

ROOM NAME

101

(101)

#

NUMBER

SECTION CALL OUT

ROOM MARKER

WINDOW REFERENCE

C

>

 \mathbf{O}

Ζ

 \mathbf{C}

S

Z

S

ШZ

4

Ш

166 VASSAL | CAMBRIDGE

NORTH ARROW

DETAIL REFERENCE

PARTITION REFERENCE

CASEWORK REFERENCE

ABBREVIATIONS


AFF	ABOVE FINISH FLOOR	OC	ON
CIP CONC	CAST-IN-PLACE CONCRETE	PCF PLAM PT	POL PLA PRF
DIA DN	DIAMETER DOWN	PVC	POL
EXIST	EXISTING	R RO	risi Rol
FIN FLR FT	FINISH FLOOR FOOT	SF SHT SIM SPEC	SQL She Sim Spe
GC GWB	GENERAL CONTRACTOR GYPSUM WALL BOARD	T T&G	TRE
HP	HIGH POINT	TYP	TYP
IN	INCH	VCT VIF	VIN VER
MAX MDF MDO MIN	MAXIMUM MEDIUM DENSITY FIBERBOARD MEDIUM DENSITY OVERLAY MINIMUM	W/ W/O	WIT WIT
MISC MO	MISCELLANEOUS MASONRY OPENING	& @ #	ane At Nui
NTS	NOT TO SCALE	#	CEN

C	ON CENTER
PLAM	POUND PER CUBIC FOOT PLASTIC LAMINATE PRESERVATIVE TREATED POLYVINYL CHLORIDE
२ २०	RISER ROUGH OPENING
SHT SIM	SQUARE FOOT SHEET SIMILAR SPECIFICATIONS
r F&G FYP	TREAD TONGUE AND GROOVE TYPICAL
/CT /IF	VINYL COMPOSITION TILE VERIFY IN FIELD
N/ N/O	WITH WITHOUT
չ @ [#] գ	AND AT NUMBER CENTERLINE

ISSUANCE: SPECIAL PERMIT

REVISION:

DATE: 11/11/2022 SCALE: 1/4" = 1'-0" DRAWN: Author CHECKED: Checker SHEET INFO: NOTES

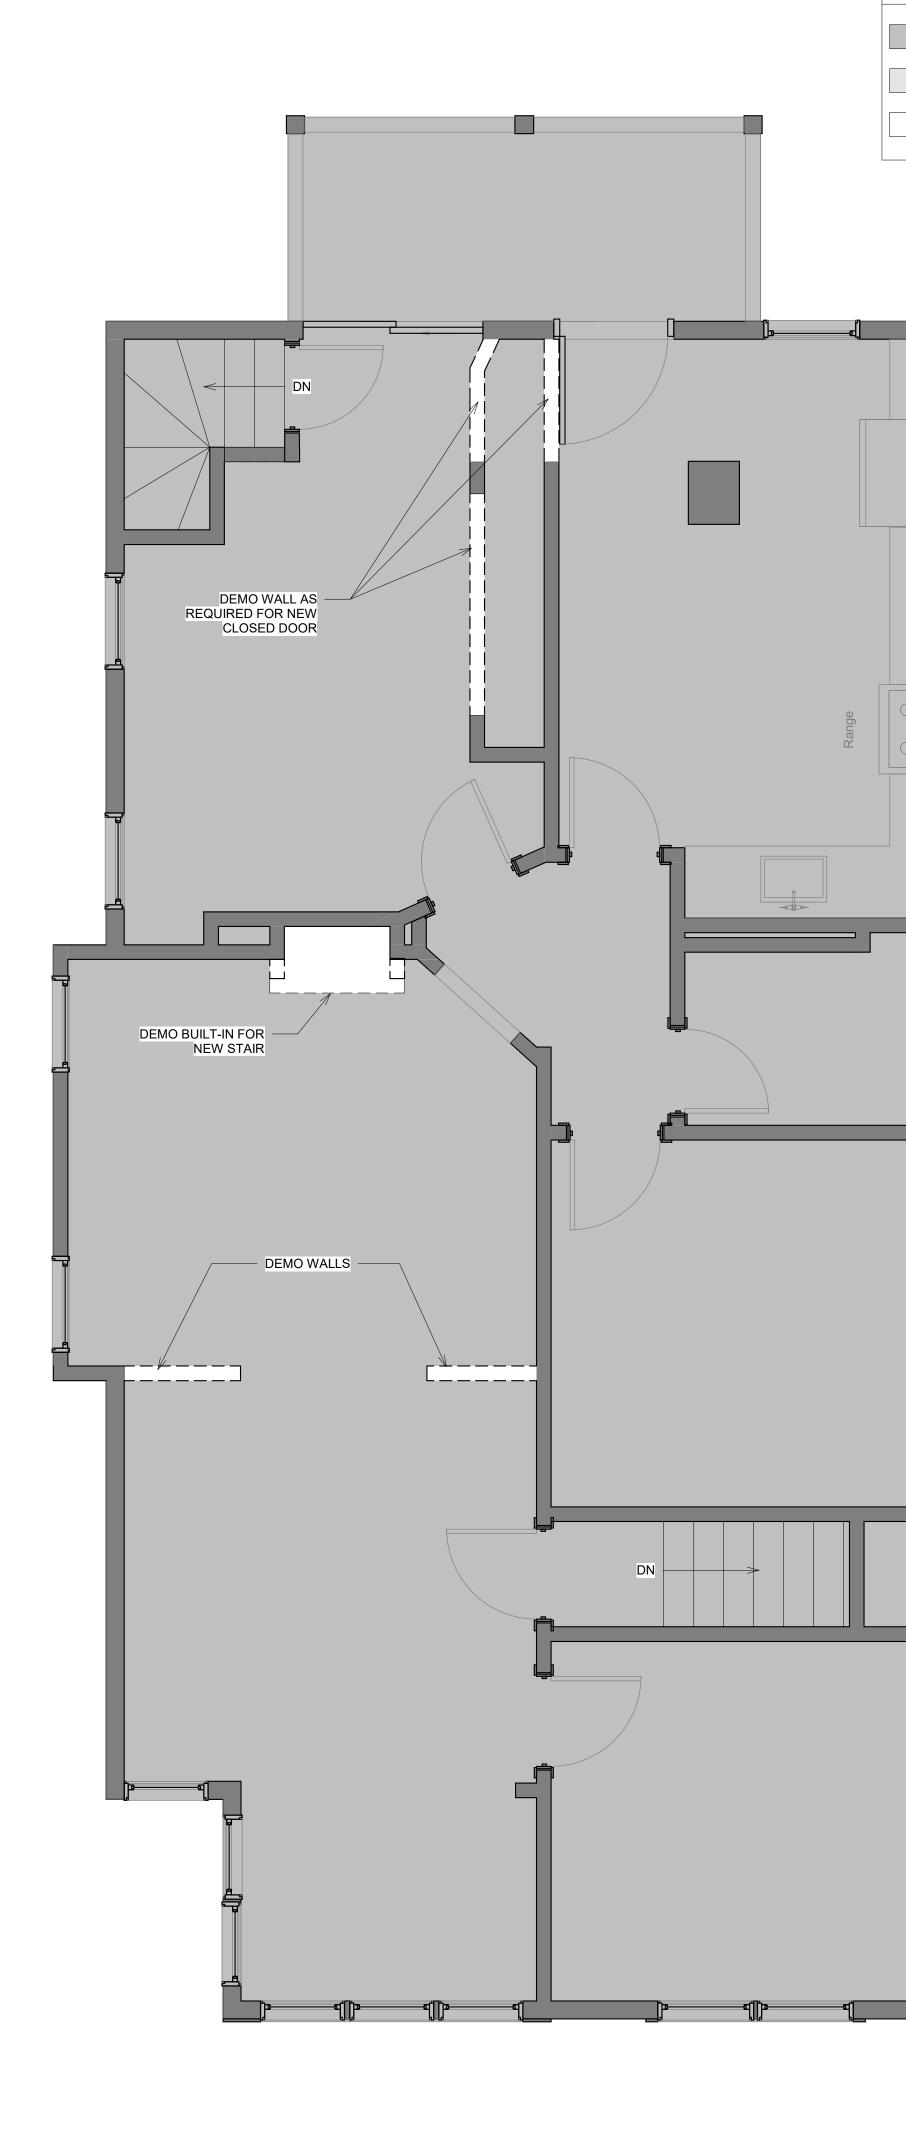





EXISTING WALLS TO REMAIN


EXISTING TO REMAIN

EXISTING TO BE REMOVED

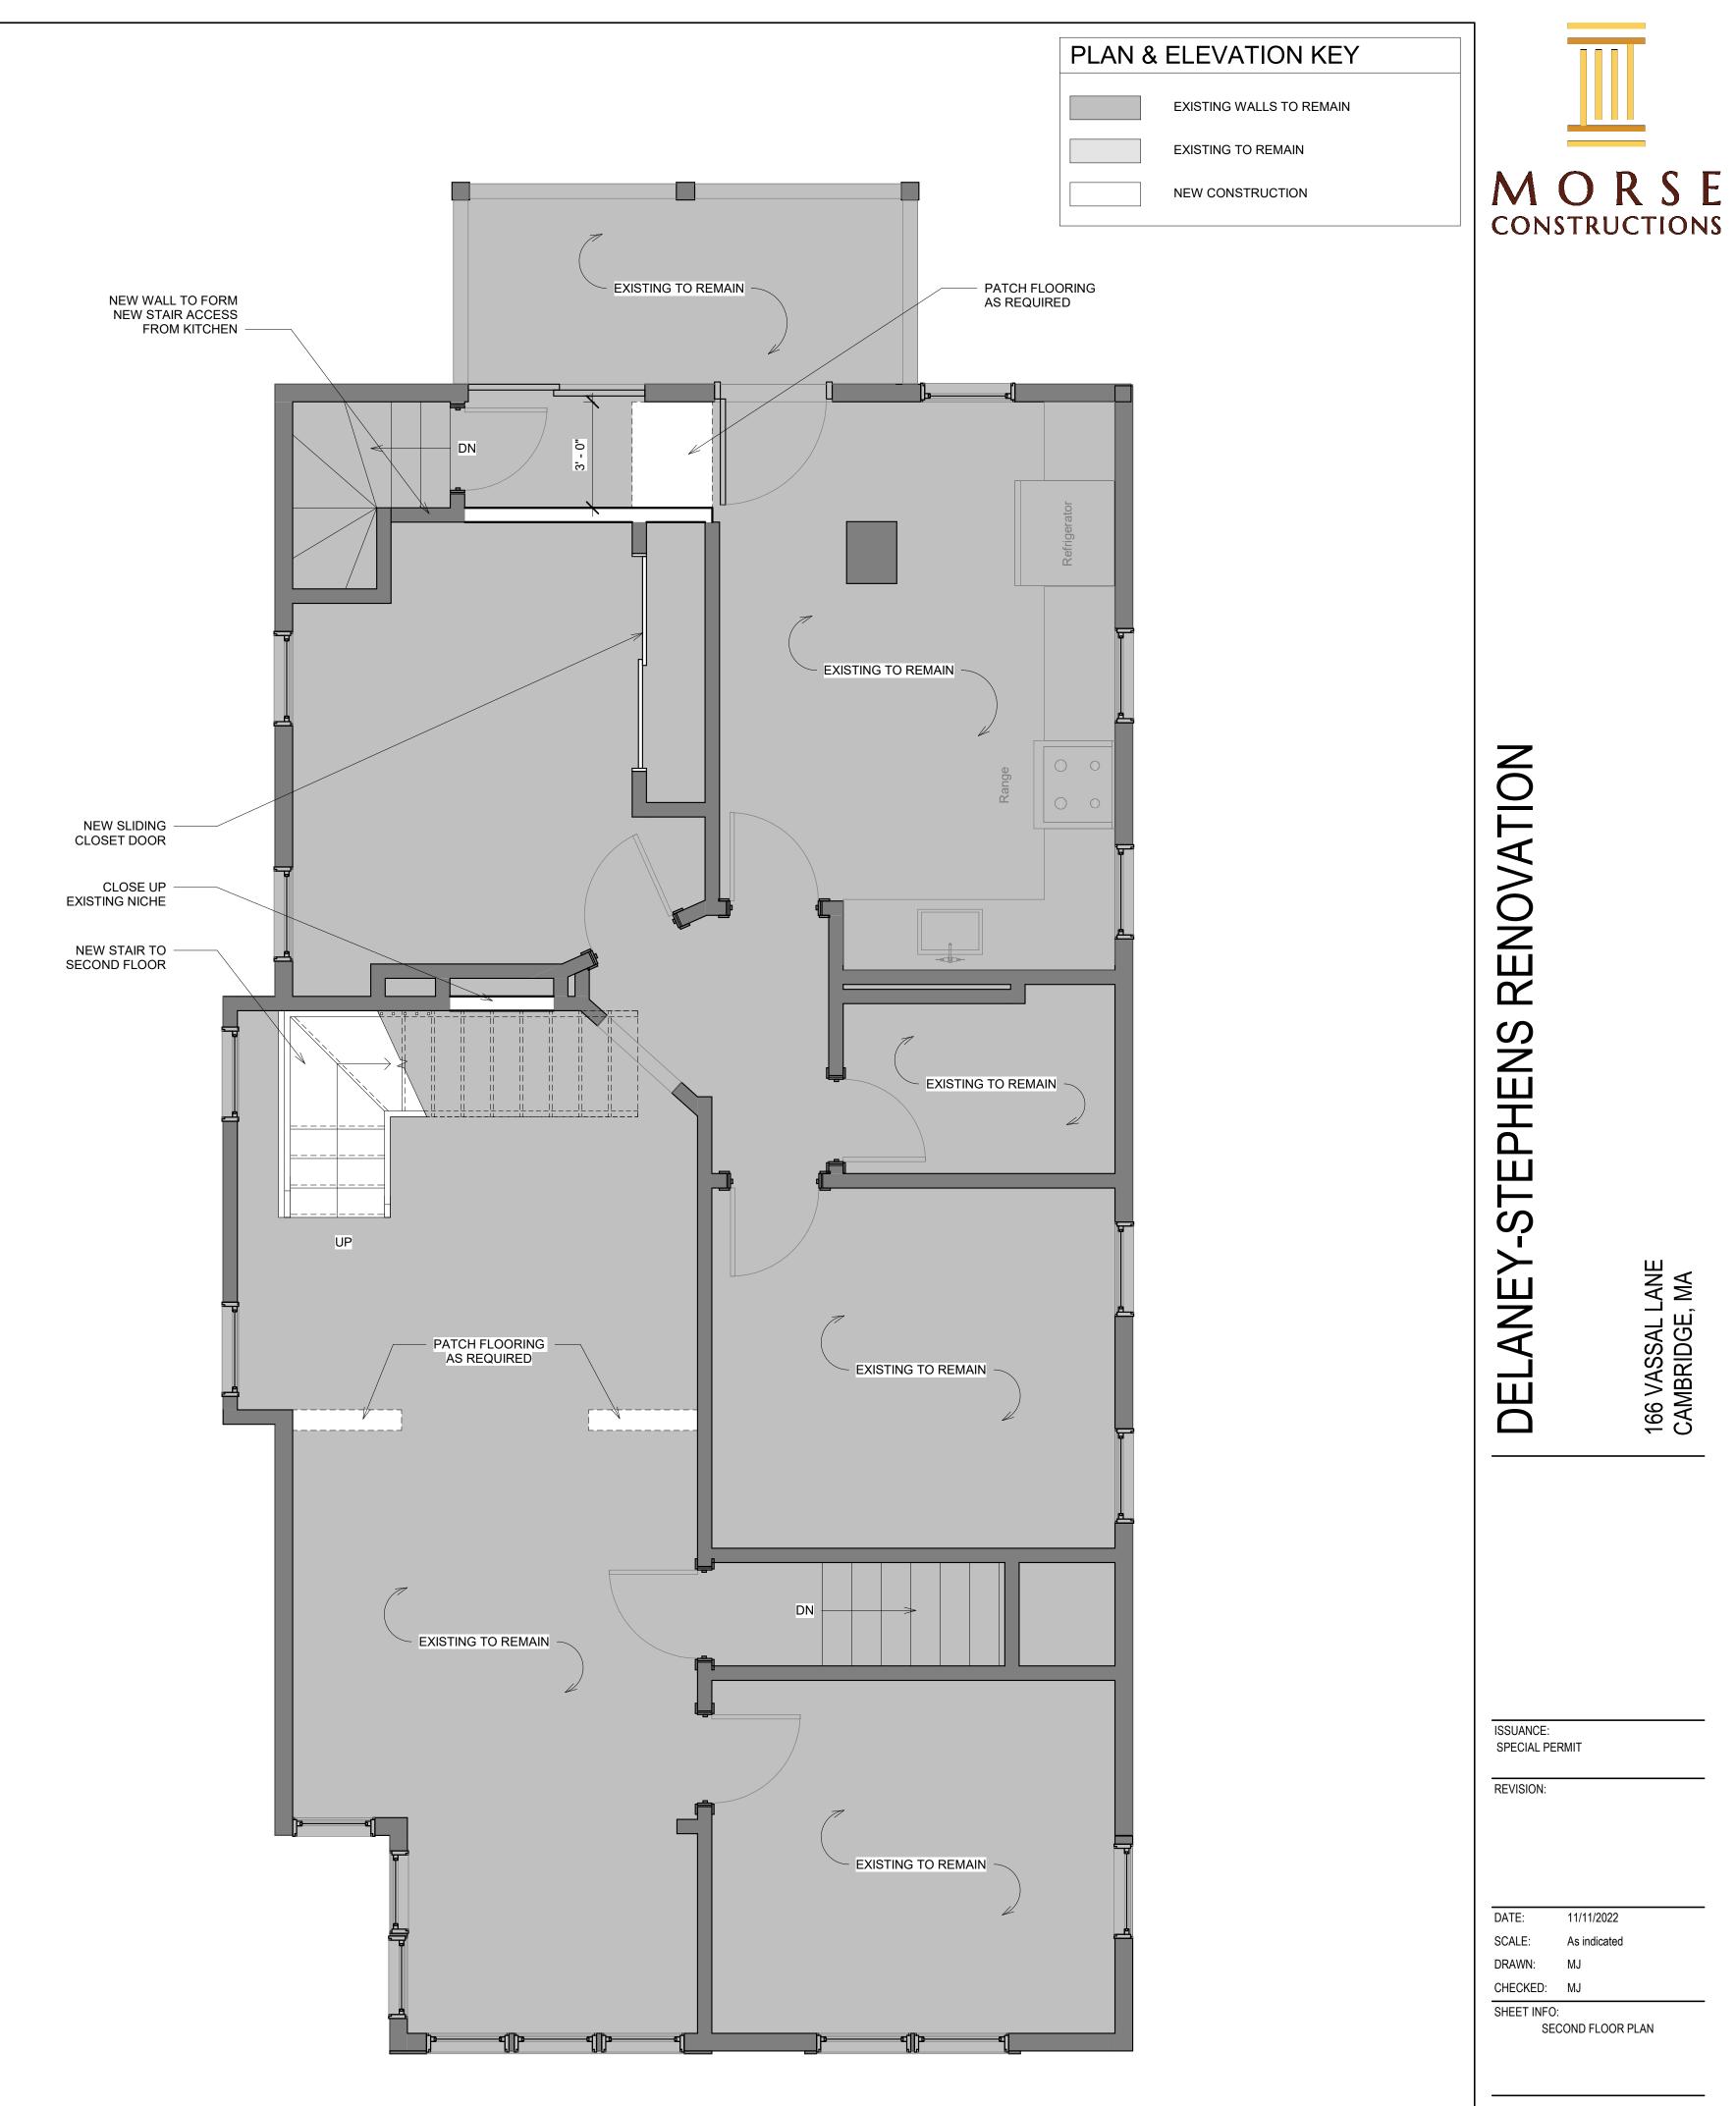

2 SECOND FLOOR 3/8" = 1'-0" A100

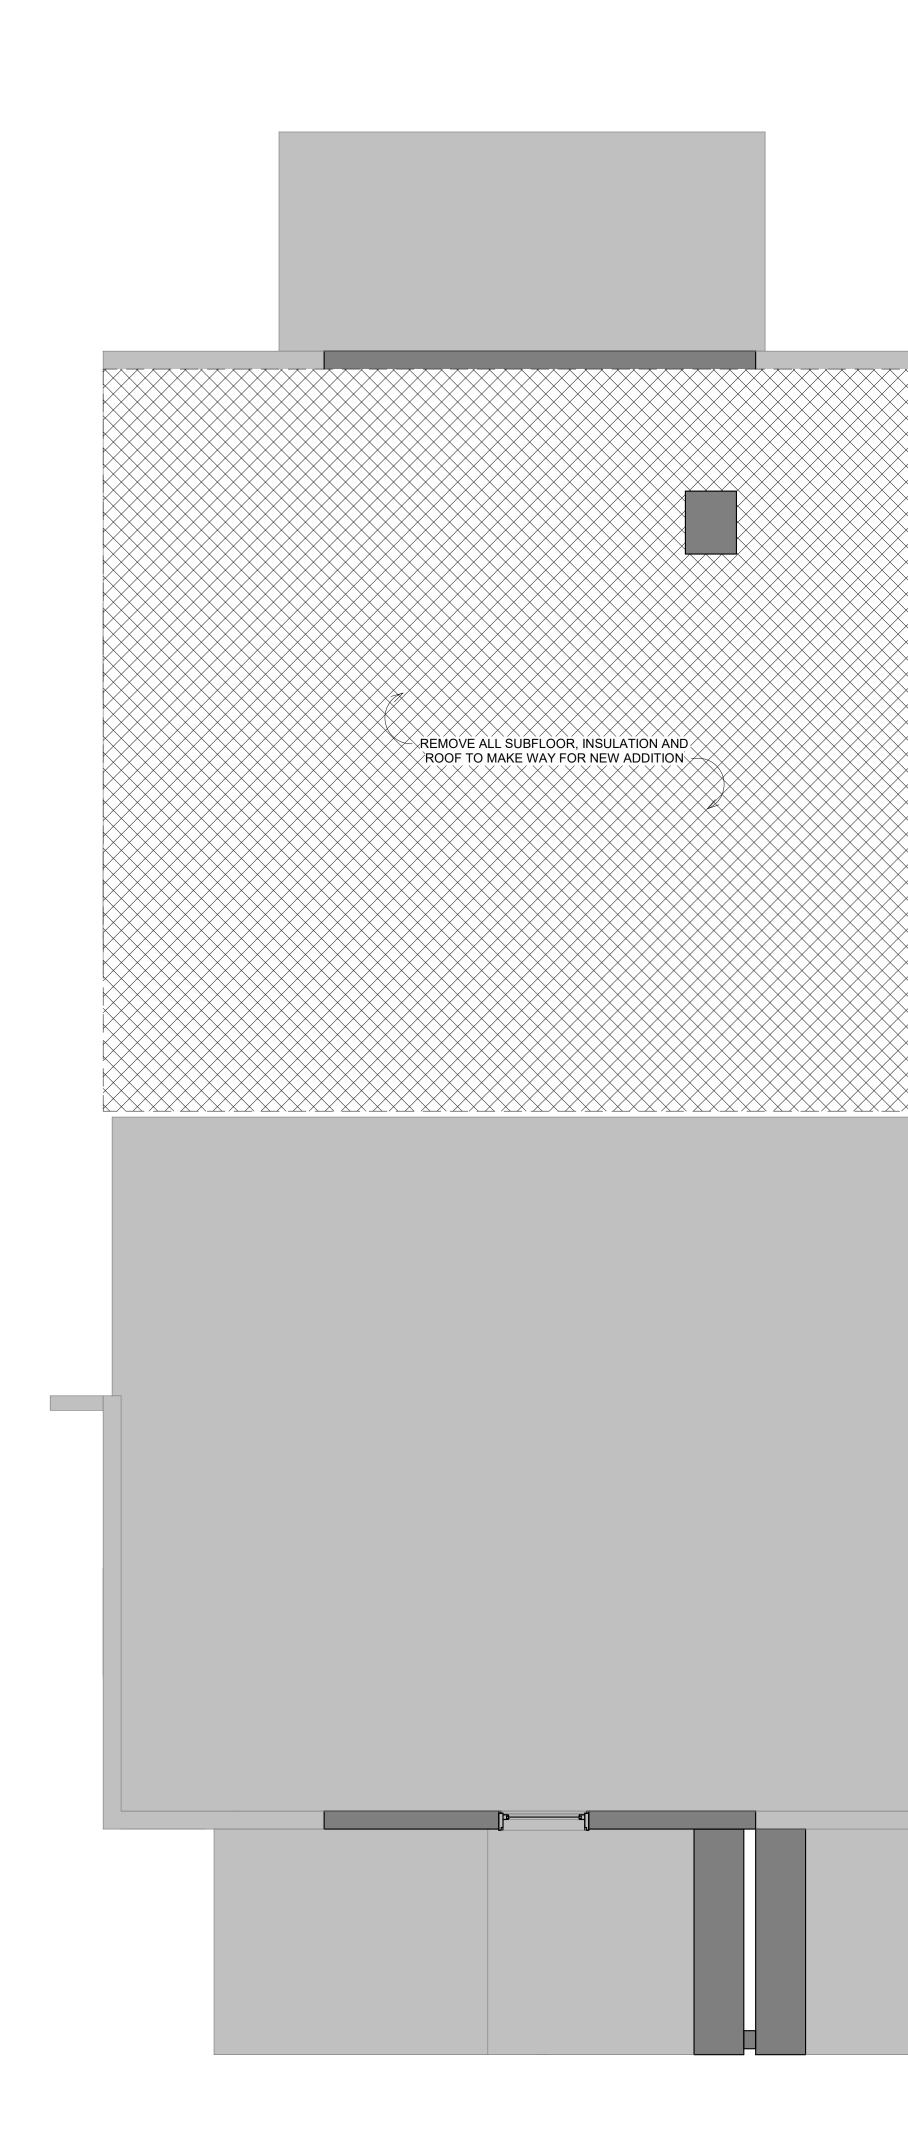

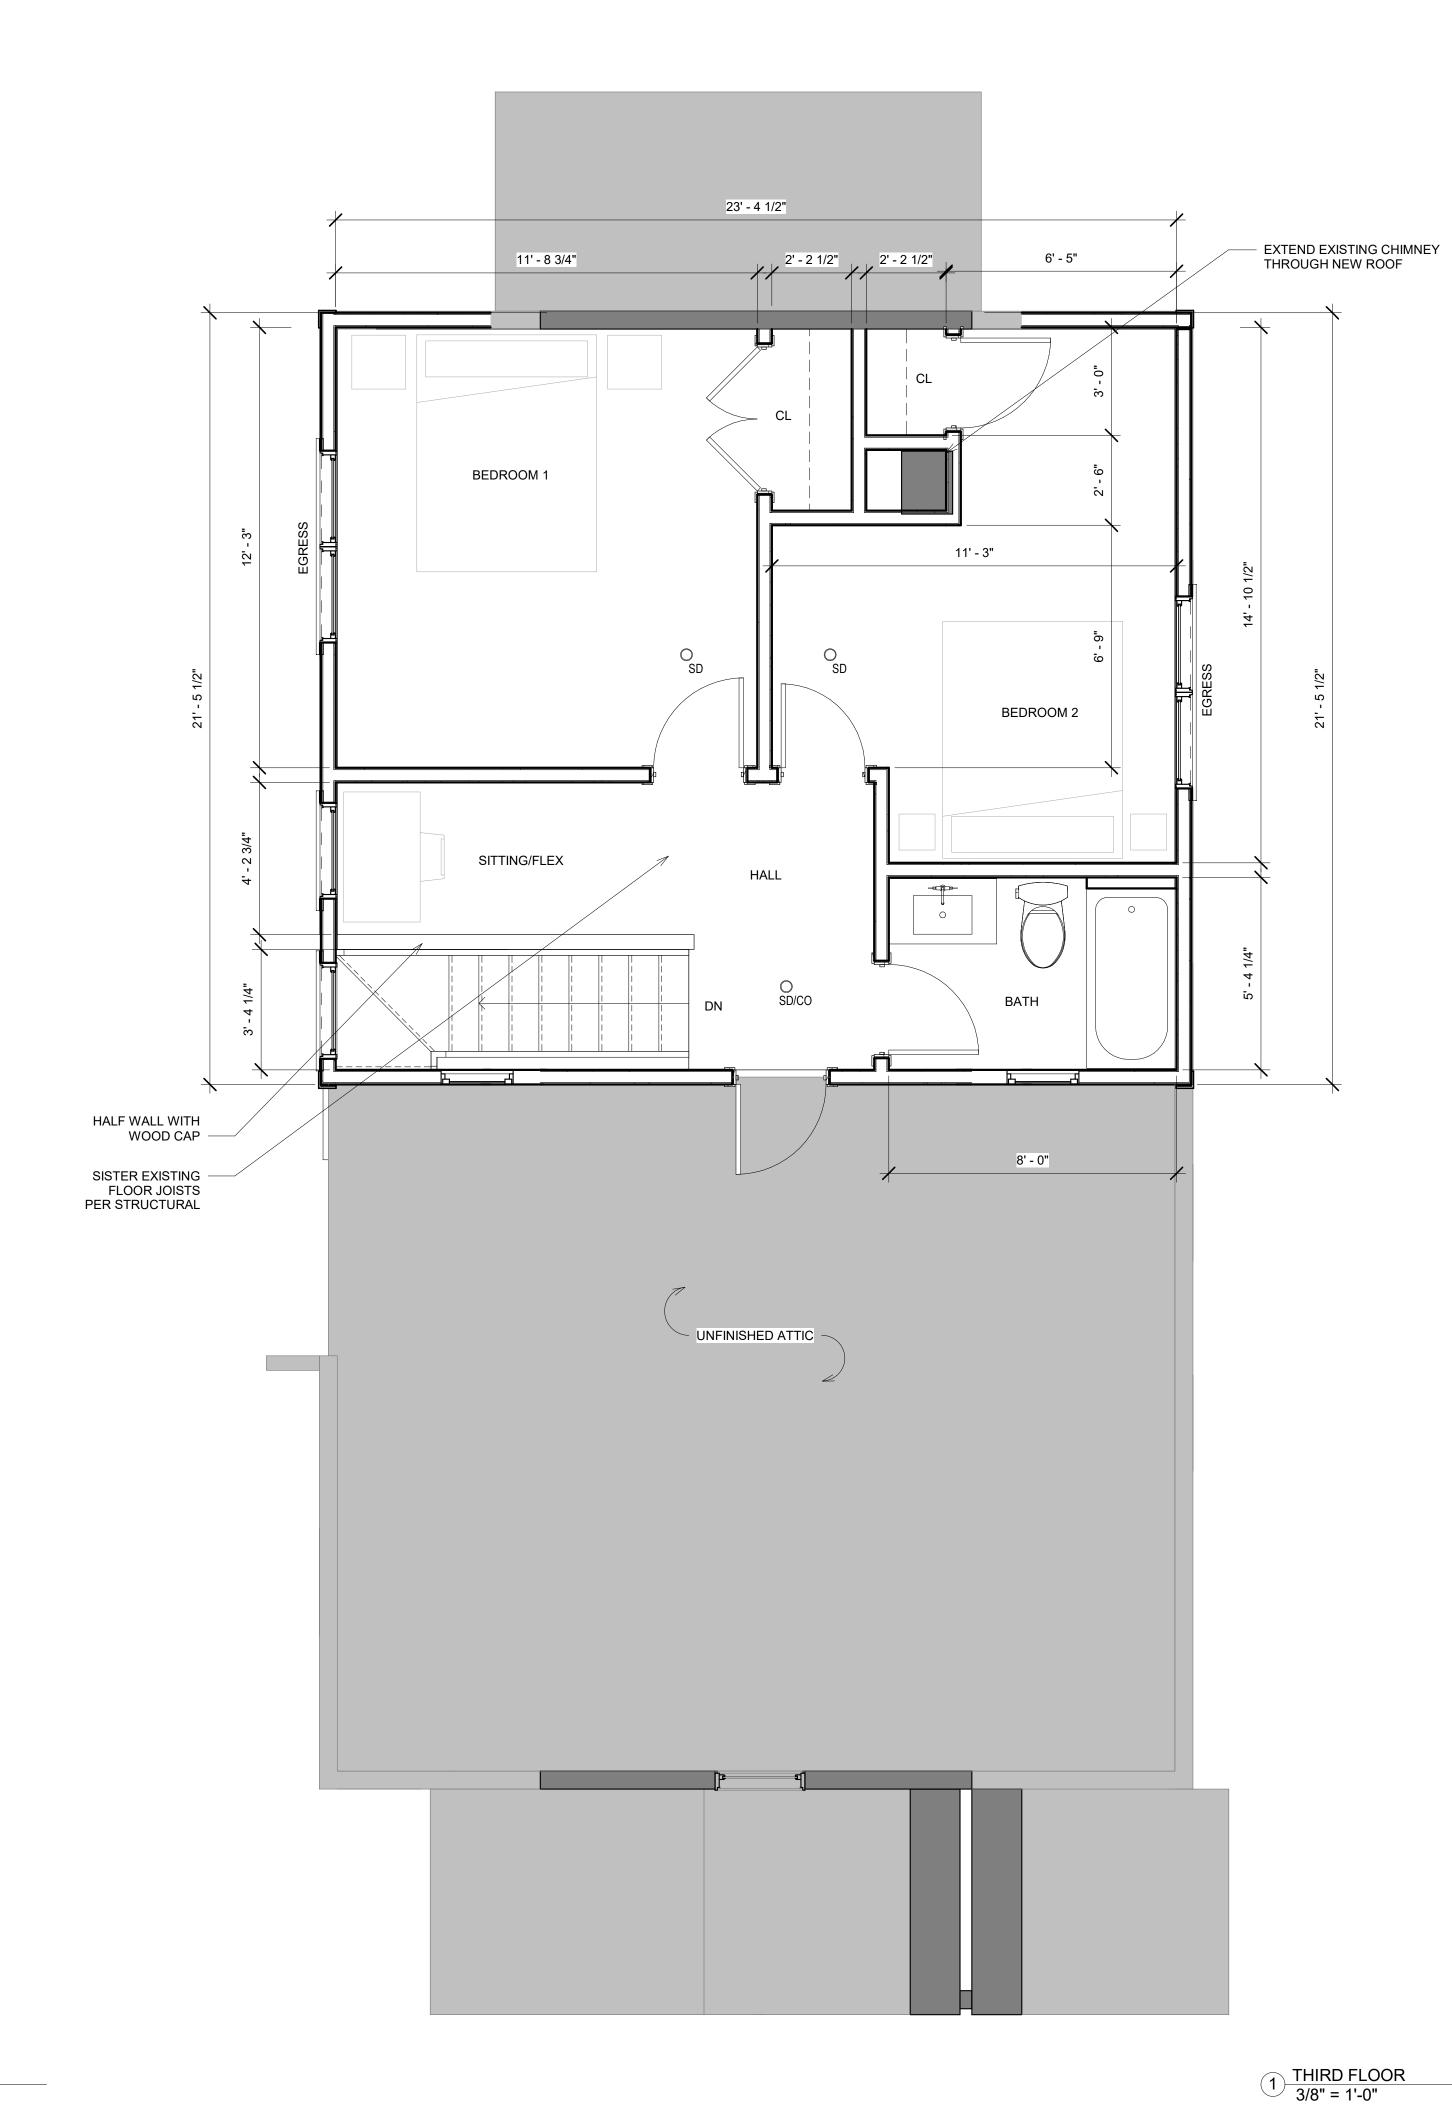



RENOVATION PHENS DELANEY-STE

166 VASSAL LANE CAMBRIDGE, MA

DATE: 11/11/2022 SCALE: 3/8" = 1'-0" DRAWN: MJ CHECKED: MJ SHEET INFO:

THIRD FLOOR PLAN

A101

REVISION:

ISSUANCE: SPECIAL PERMIT







HOUSE DIRECTLY TO THE LEFT WITH SIMILAR THIRD FLOOR ADDITION





LEFT

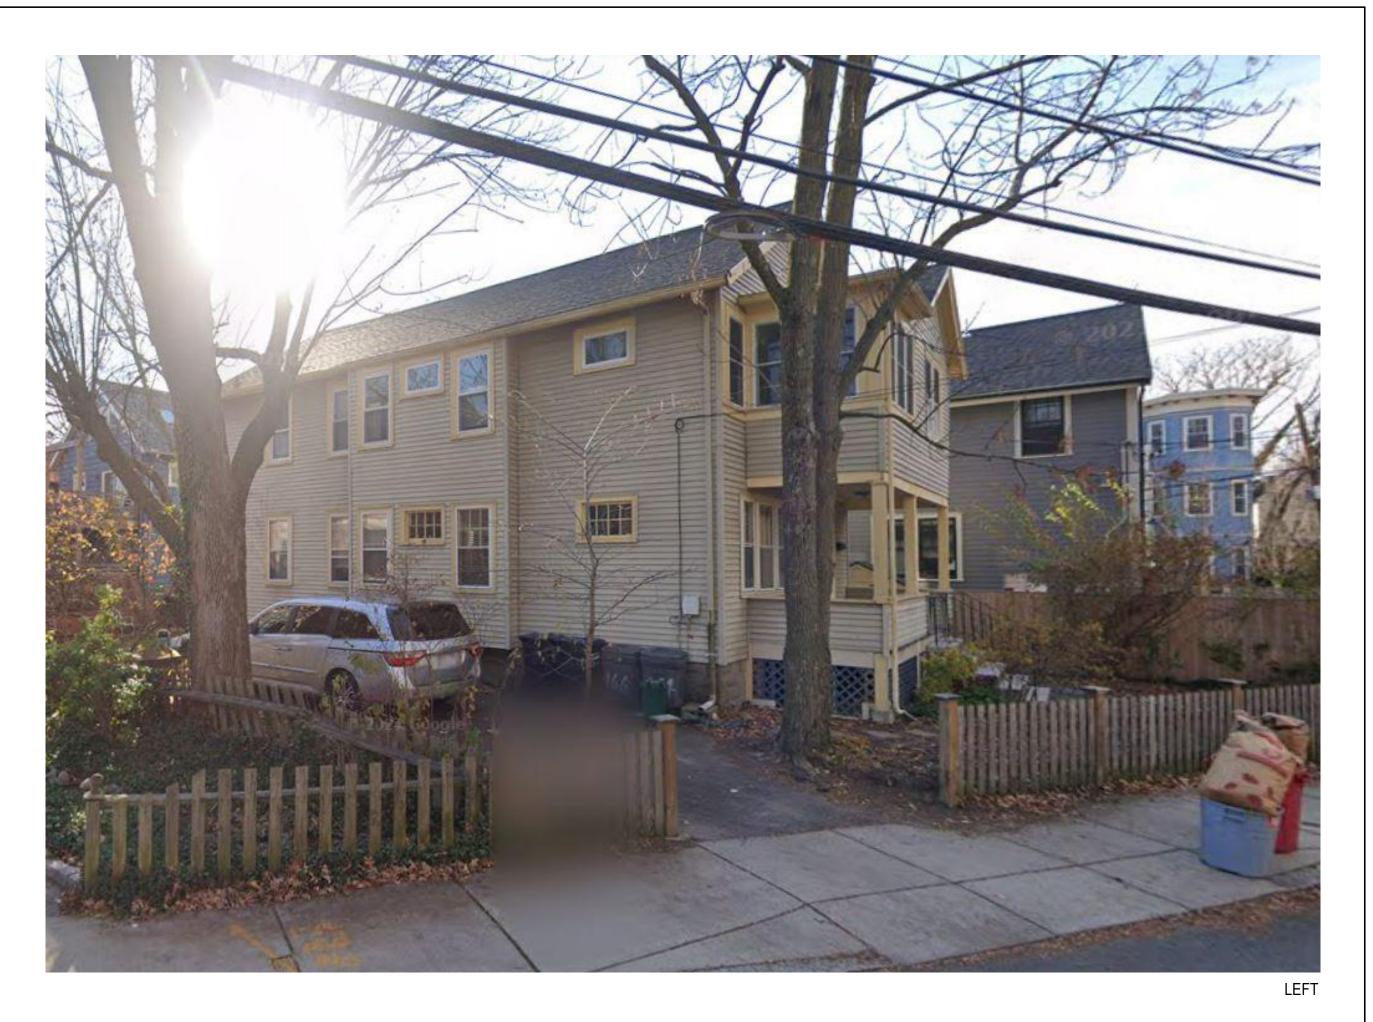

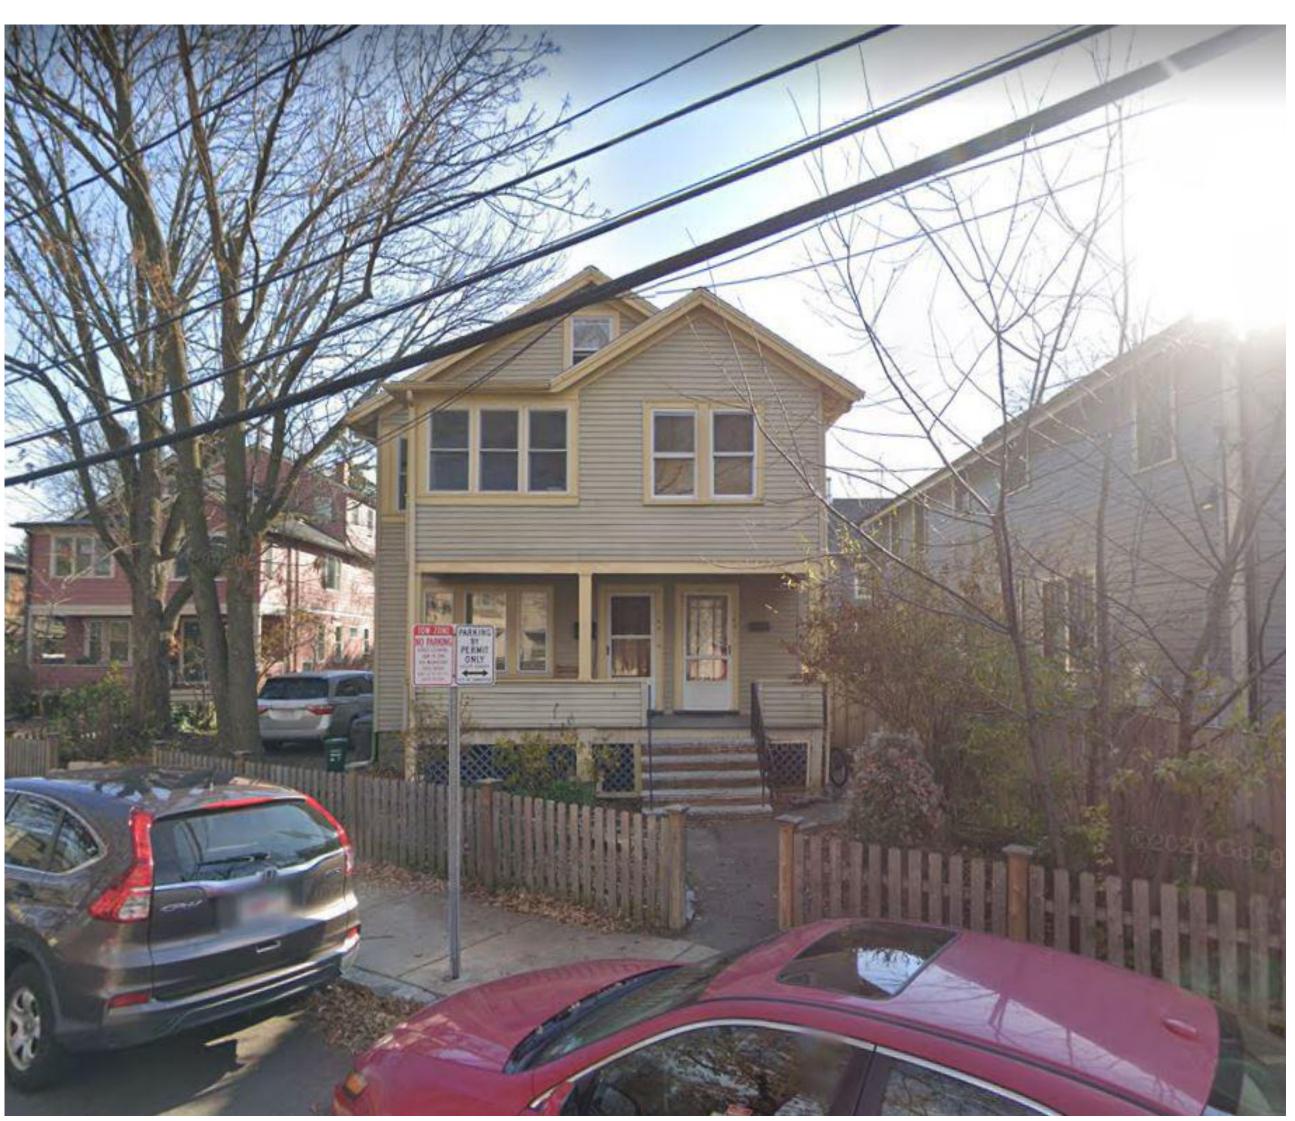

BACK



RENOVATION PHENS μ S \succ ANE DEL

ANE	MA
SSAL I	IDGE,
66 VAS	AMBR
16	S


DATE:	11/11/2022	
SCALE:		
DRAWN:	MJ	
CHECKED:	MJ	
SHEET INFO:		
	PHOTOS	


ISSUANCE: SPECIAL PERMIT


REVISION:

A102

FRONT

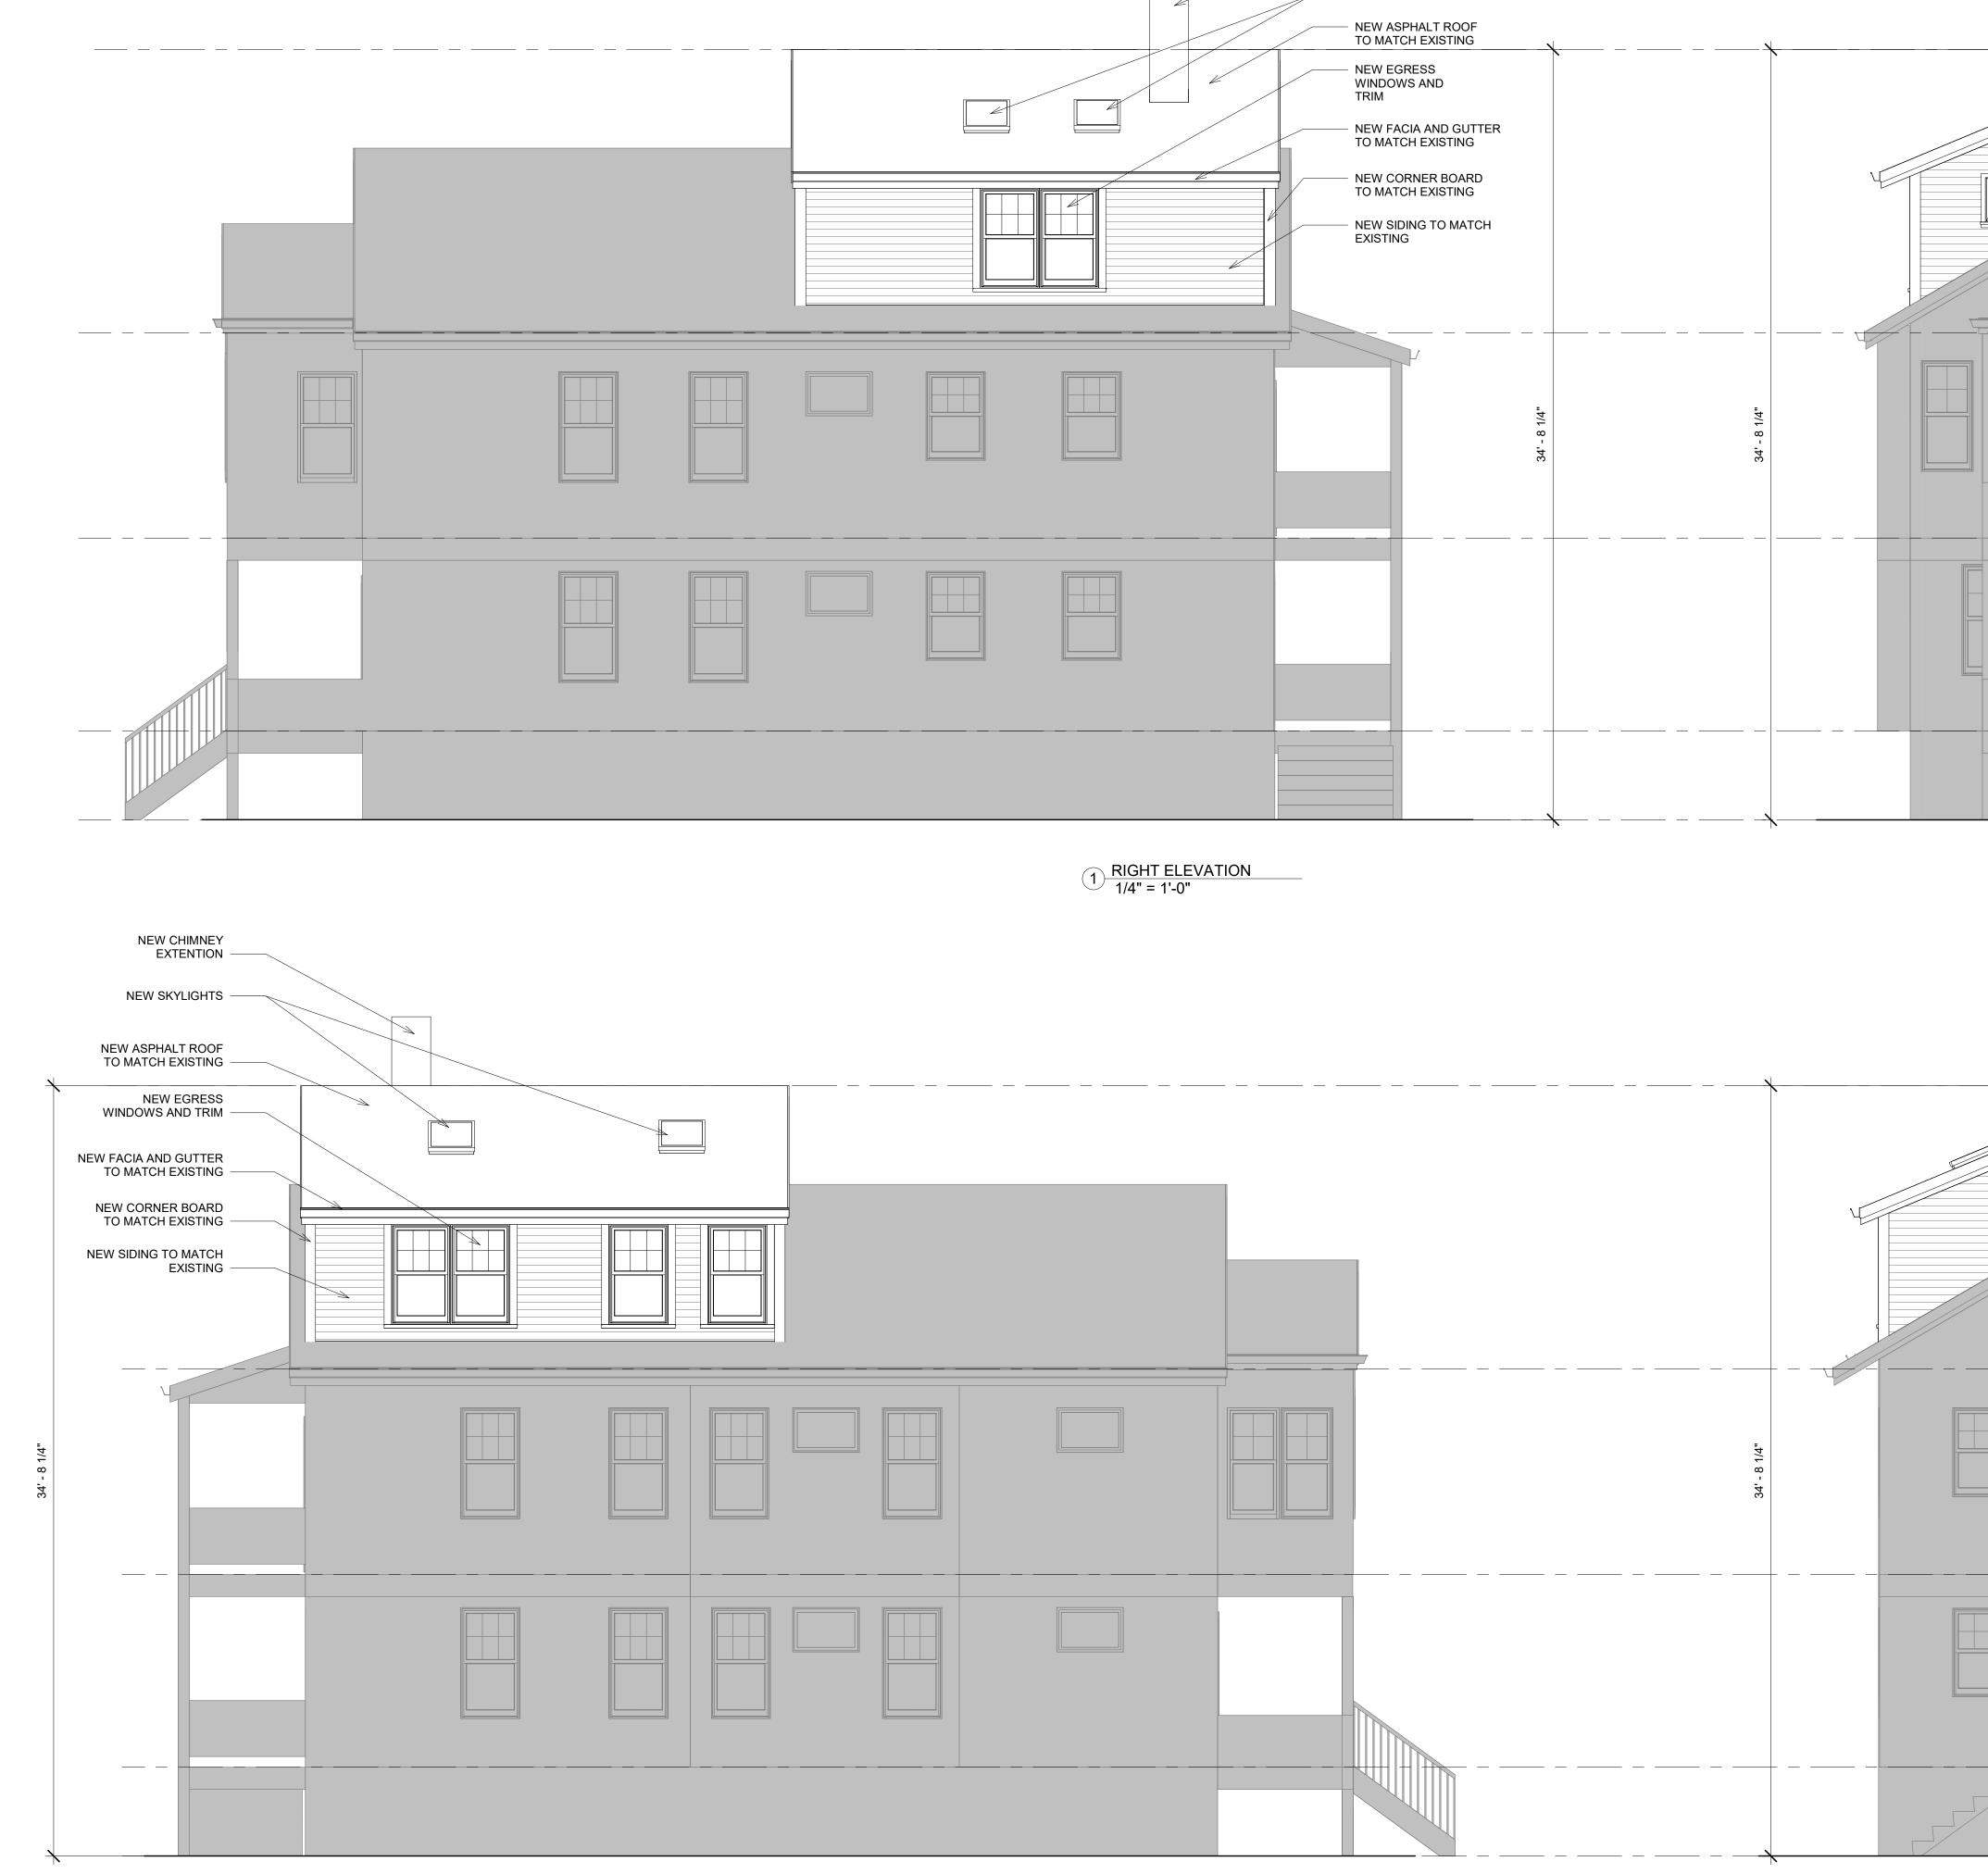


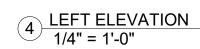

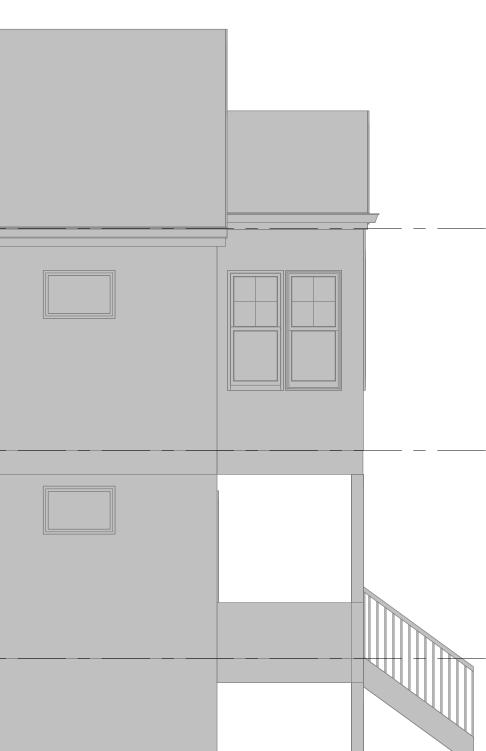



NEW CHIMNEY EXTENTION - NEW SKYLIGHTS

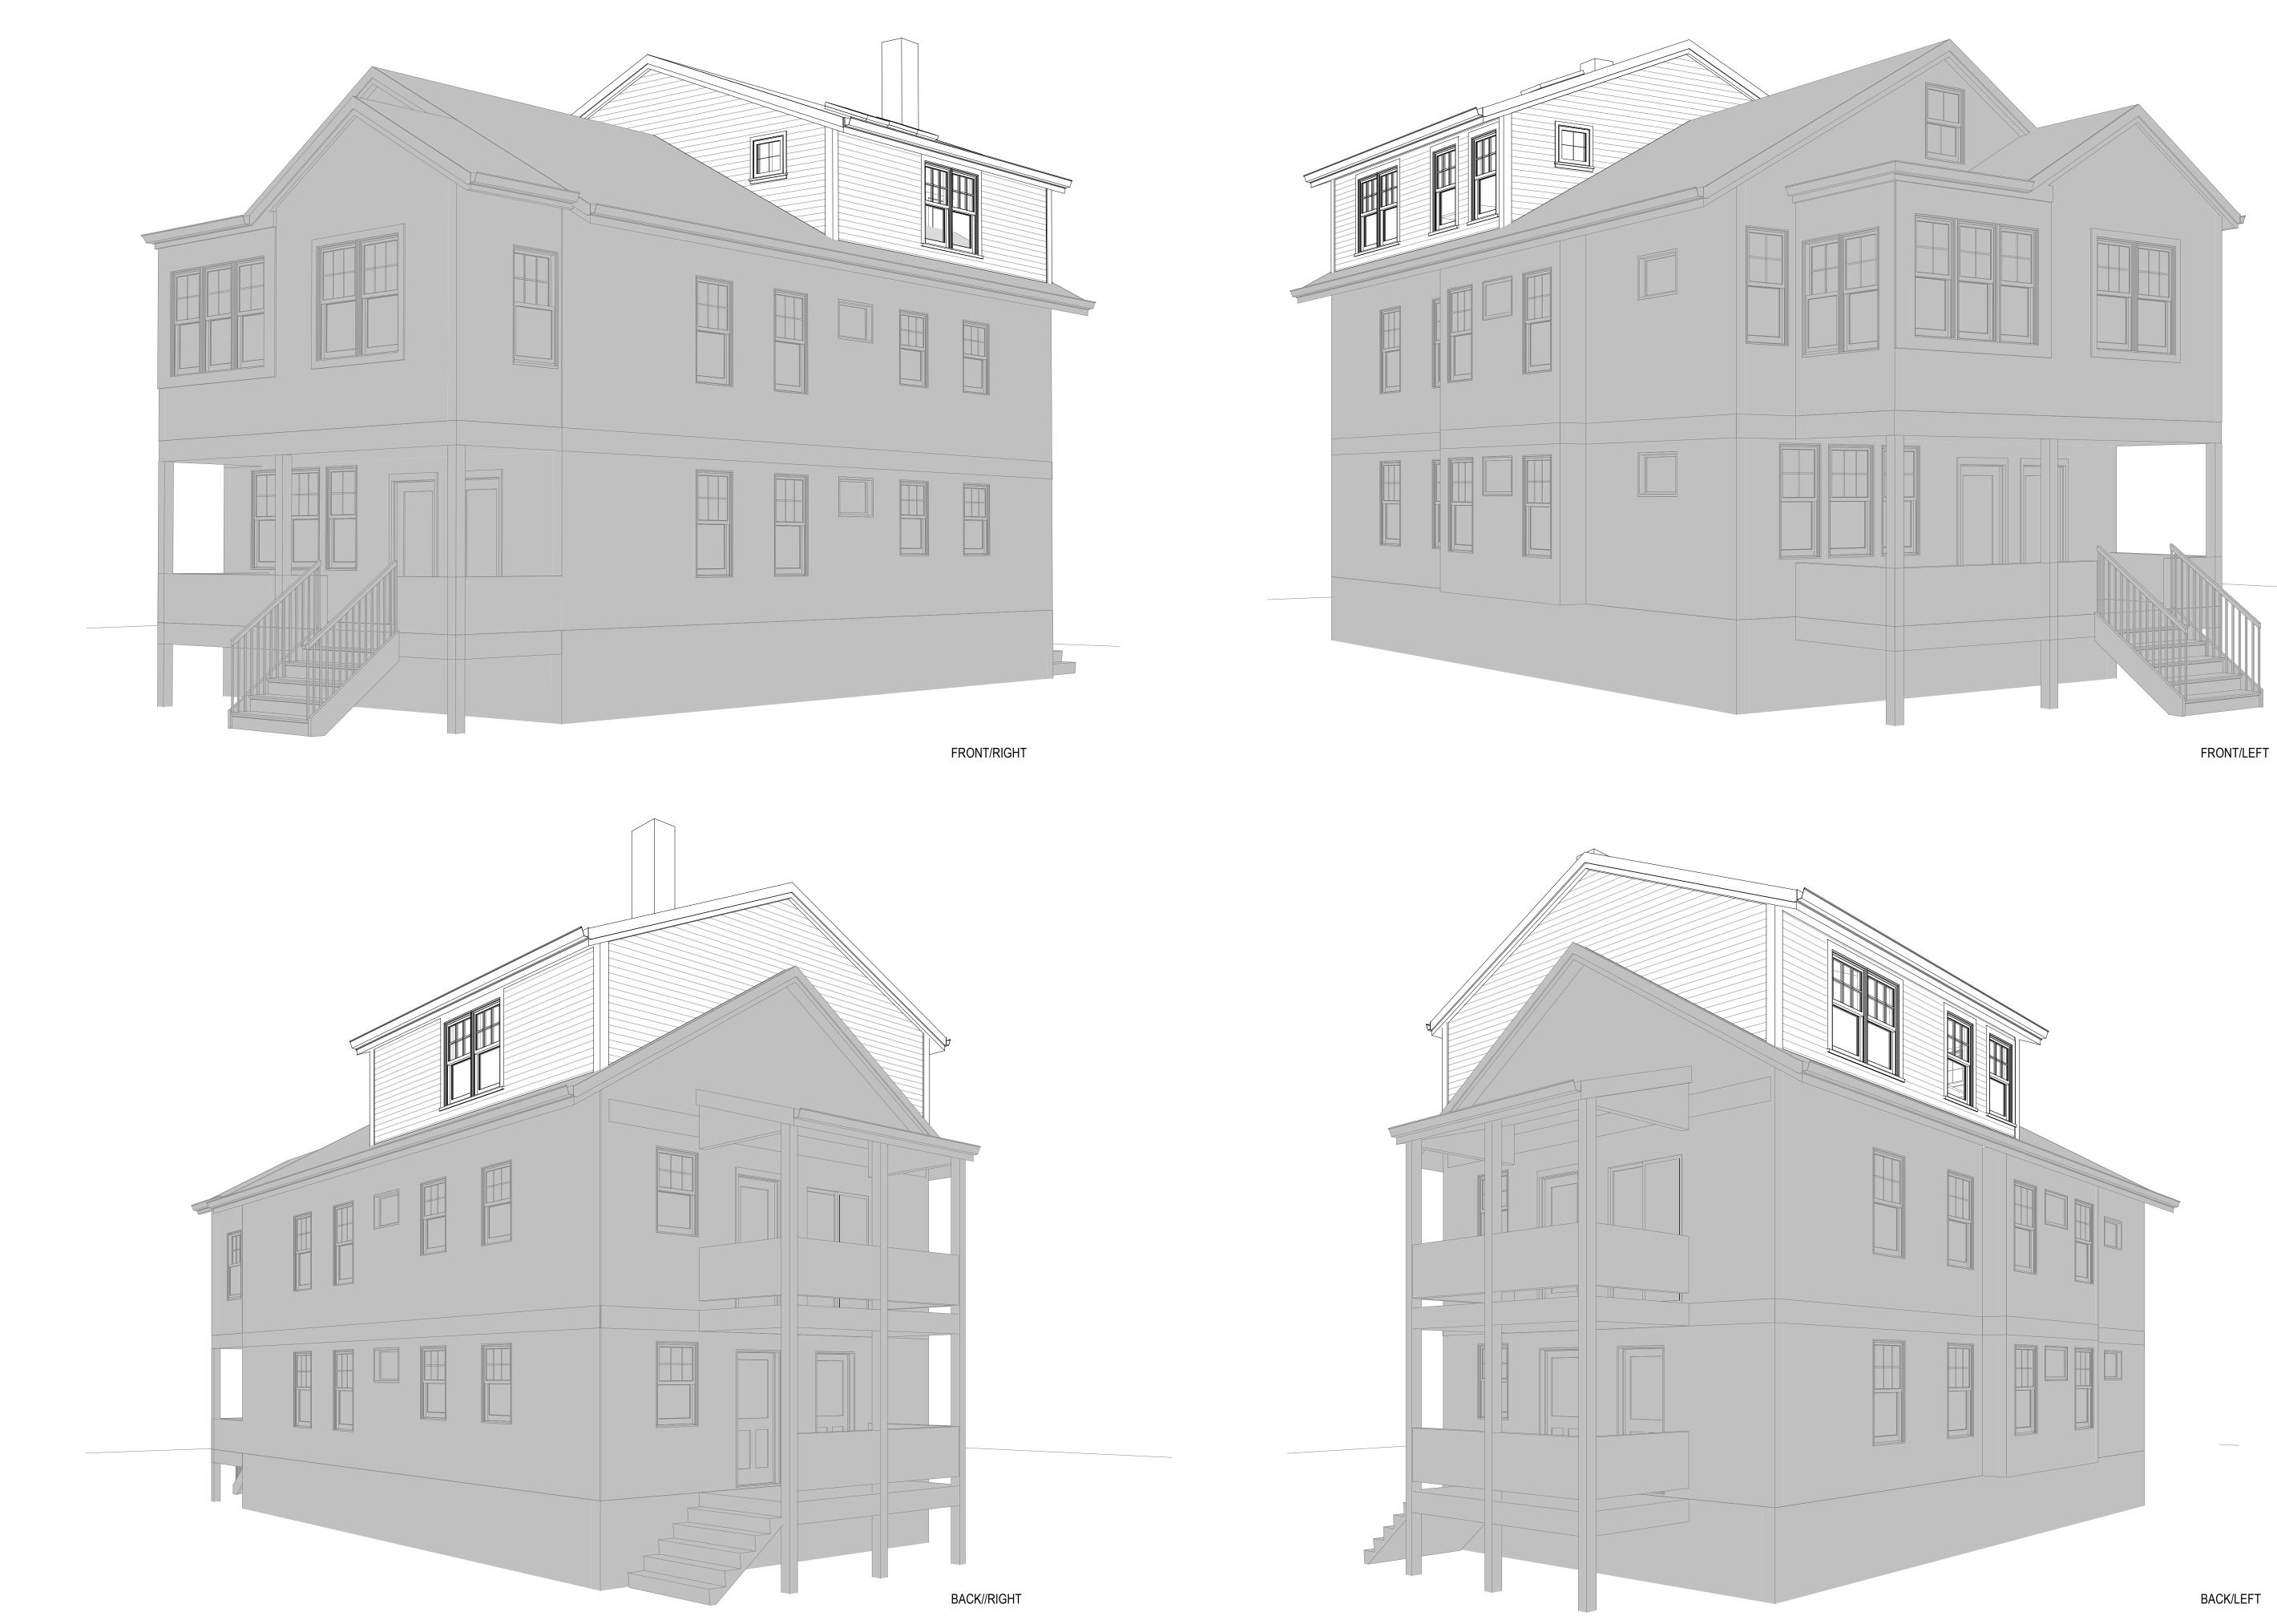



MORSE CONSTRUCTIONS

DELANEY-STEPHENS RENOVATION


166 VASSAL LANE CAMBRIDGE, MA

ISSUANCE: SPECIAL PERMIT

REVISION:


DATE:	11/11/2022
SCALE:	
DRAWN:	Author
CHECKED:	Checker
SHEET INFO:	
	3-D VIEWS



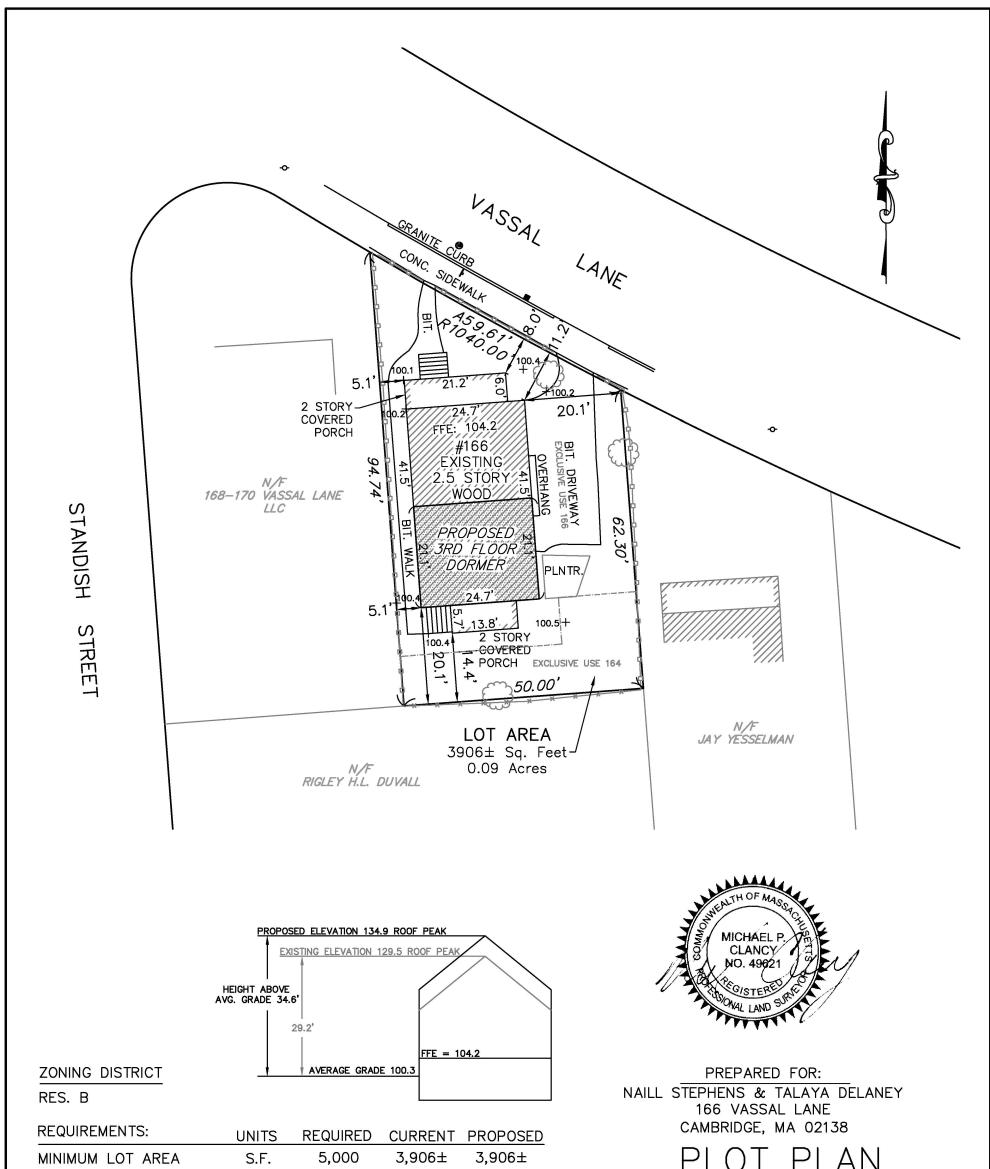

MINIMUM LOT AREA	S.F. 5,00	0 3,906±	3,906±	P(0) P(AN) = 1
MINIMUM LOT WIDTH	FT. 50.0	50.0	50.0	
FRONT SETBACK	FT. 15.0	8.0	8.0	FOR
SIDE SETBACK	FT. 7.5 (20	SUM) 5.1(25.2)	5.1(25.2)	164-166 VASSAL LANE
REAR SETBACK	FT. 25.0	14.4	14.4	
BUILDING HEIGHT	FT. 35.0	29.2	34.6	IN
PRIVATE OPEN SPACE	% 40.0	18.4	18.4	
				CAMBRIDGE, MA.
				SCALE: 1"=20' OCTOBER 28, 2022
NOTES:				SCALE. I - 20 OCTOBER 20, 2022
1. ZONING CLASSIFICATION	ON — RES. B			C & G SURVEY COMPANY
2. MASTER DEED:				37 JACKSON ROAD
	TH REGISTRY OF D	EEDS BOOK 65	418 PAGE 58	9 SCITUATE, MA. 02066
3. PLAN REFERENCES:	TH REGISTRY OF D			1-877-302-8440
	TH REGISTRY OF D			PLAN REVISED: 11-10-22
4. ASSESSORS PARCEL			50 01 2007	
4. ASSESSONS FARCEE	10. 200-107-104	& 100		0 10 20 40 60 80
			FEET	
			METERS	0 5 10 15 20 25
				0 5 10 15 20 25

164-166 Varsal Jane #166

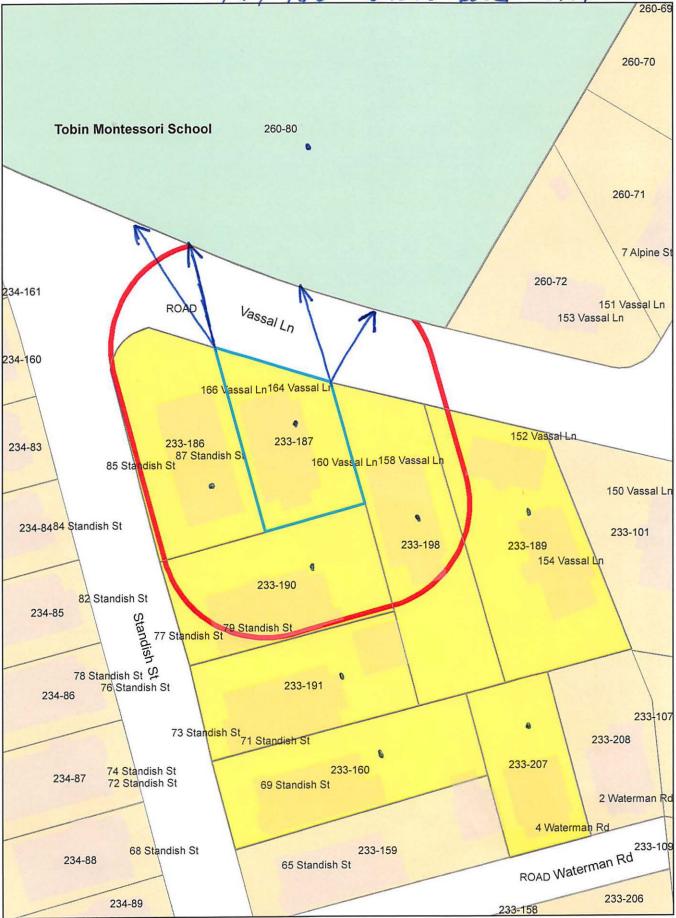

233-160 GIANAKOS, ELIZABETH 69 STANDISH STREET, UNIT #2 CAMBRIDGE, MA 02138

233-160 LEI, YA-WEN 69 STANDISH ST., #3 CAMBRIDGE, MA 02138

233-187 BUJOREANU, MIHAELA 164 VASSAL LN CAMBRIDGE, MA 02138

233-160 DIZON, VINCENT, TR. OF THE VINCENTE MARIA DIZON 2019 LIVING TRT 639 WEST END AVE UNIT #2D NEW YORK, NY 10025

233-186 CRARY, HARRIET S. 85 STANDISH ST CAMBRIDGE, MA 02138

260-80 CAMBRIDGE CITY OF SCHOOL DEPT / TOBIN SCHOOL 159 THORNDIKE ST CAMBRIDGE, MA 02141

164-166 Vassal lane # 169 Petitioner

233-190 DUVALL, RIGLEY H. L. & KATHERINE LUM 77 STANDISH ST. CAMBRIDGE, MA 02138

233-191 FLAMM, HARRY S. & AMY E. MUNSAT 71-73 STANDISH ST CAMBRIDGE, MA 02138-6816

233-207 ROACH, TIMOTHY M. & ANDREA C. KRAMER 4 WATERMAN RD CAMBRIDGE, MA 02138

233-189 KENTON SCOTT 152 VASSAL LN CAMBRIDGE, MA 02138

233-186 KIM, JINAH MYUNG-KOO KANG 87 STANDISH ST CAMBRIDGE, MA 02138

260-80 CITY OF CAMBRIDGE C/O NANCY GLOWA CITY SOLICITOR STEPHENS, NIALL & TALAYA DELANEY 166 VASSAL LN CAMBRIDGE, MA 02138

JARED GARDINER, CONTRACTOR 1 ARROW DRIVE WOBURN, MA 01801

233-189 RUTHERFORD MATTHEW S & BRIDGET M TR RUTHERFORD FAMILY TRUST 154 VASSAL LN CAMBRIDGE, MA 02138

233-198 YESSELMAN, JAY 160 VASSAL LN CAMBRIDGE, MA

260-80 CITY OF CAMBRIDGE C/O YI-AN HUANG CITY MANAGER

Pacheco, Maria

From: Sent: To: Subject: JAY YESSELMAN <jbyes@comcast.net> Wednesday, January 18, 2023 5:20 PM Pacheco, Maria Case no. BZA-202716

Hello Ms Pacheco

I am a direct abutter to this property. I live at 160 Vassal Ln. Niall has shared the plan with me. I have no objections to it. Living right across the street from the construction project at The Tobin School and having lived through the 5 years of sewer separation project on Vassal Ln I am fed up with the noise and and debris and pollution. I am hopeful you will approve this project in a timely manner so that by the time the school project is complete this project will be complete and we can have some peace, quiet and clean air in our neighborhood for some period of time.

Jay Yesselman 160 Vassal Ln



City of Cambridge

MASSACHUSETTS

BOARD OF ZONING APPEAL

831 Mass Avenue, Cambridge, MA. (617) 349-6100

BZA

POSTING NOTICE – PICK UP SHEET

The undersigned picked up the notice board for the Board of Zoning Appeals Hearing.

Name:	LEE Maseniert.			Date: 1/10/23	
Address:	164-14	(Print) 6 Vasal	lane	#164	

Case No. <u>BZA - 202716</u> Hearing Date: <u>1/26/23</u> Hearing Date: ____

Thank you, **Bza Members**

Pacheco, Maria

From: Sent: To: Cc: Subject: Niall Stephens <niall.stephens@gmail.com> Monday, January 23, 2023 12:52 PM Pacheco, Maria Talaya Delaney BZA-202716 continuance request

Dear Maria,

We request a continuance of our Case BZA-202716 at 166 Vassal Lane.

We would like to be heard on March 23 instead of this week.

As such we will not attend the BZA hearing this Thursday (1/26).

Can you please confirm that this is acceptable and also tell us when the deadline for our revised plans is.

Thank you very much,

Niall Stephens and Talaya Delaney

166 Vassal Lane (BZA-202716)