7/25/23, 9:27 AM about:blank



CITY OF CAMBRIDGE

BOARD OF ZONING APPEAL

831 Massachusetts Avenue, Cambridge MA 02139

617-349-6100

BZA Application Form

BZA Number: 233716

General I	nformation
-----------	------------

	O SALVE M. ASIA CO. A	
The undersigned	hereby petitions the Board of Zoning Appeal for the following:	
Special Permit: _	X Variance: Appeal:	
PETITIONER:	Kimberly C. Mott and Jesse A. Mott C/O Michael W. Wiggins, Attorney	
PETITIONER'S	S ADDRESS: one Liberty Square Suite 1210, Boston, MA 02109	
LOCATION OF	PROPERTY: 63 Clarendon Ave , Cambridge, MA	
TYPE OF OCCU	JPANCY: Two Family ZONING DISTRICT: Residence B Zone	
REASON FOR I	PETITION:	
/Change in Use/C	Occupancy/ /Dormer/	
DESCRIPTION	OF PETITIONER'S PROPOSAL:	
dormers on third	to increase FAR by .113 of this prior nonconforming structure, by raising the roof and installing floor, additional framing of roof awnings at front and rear porches, and relocating front stairs to also to refenestrate on right side of building within the right side setback	
SECTIONS OF 2	ZONING ORDINANCE CITED:	
Article: 5.000 Article: 8.000 Article: 10.000	Section: 5.31 (Table of Dimensional Requirements). Section: 8.22.2.d & Sec. 8.22.2.c (Nonconforming Structure). Section: 10.40 (Special Permit). Original Signature(s): (Petitioner (s) / Owner) Michael M. Maggins (Print Name)	• - 4
	Address: One Liberty Sq. Still Butty A Tel. No. 6178806313 E-Mail Address: many@westonpatrick.com	39

BZA APPLICATION FORM - OWNERSHIP INFORMATION

To be completed by OWNER, signed before a notary and returned to The Secretary of the Board of Zoning Appeals.

I/We Kimberly C. Mott and Jesse A. Mott
Address: 63 Clarendon avenue Cambridge
State that I/We own the property located at 63-65Clavendon Avenue
which is the subject of this zoning application.
The record title of this property is in the name of Kimberly C. MotT and Jesse A. Mott
A
*Pursuant to a deed of duly recorded in the date $12/4/2020$ Middlesex South
County Registry of Deeds at Book 76347 , Page 81 ; or
Middlesex Registry District of Land Court, Certificate No
Book Page Amount or . Wiggmo attorney for Kimberly C. Mott and Tesse A. Mott
SIGNATURE BY LAND OWNER OR
AUTHORIZED TRUSTEE, OFFICER OR AGENT*
*Written evidence of Agent's standing to represent petitioner may be requested.
•
Commonwealth of Massachusetts, County of Svffolk
The above-name Michael W. Wogins personally appeared before me,
this 190 of July, 2023, and made gath that the above statement is true.
Should Iller MA Survey
TRACY A. MOLONEY Notary Public
My commission expires 5/30/202 (Notary Seal). Commonwealth of Massachusetts
My Commission Expires May 20, 2027

• If ownership is not shown in recorded deed, e.g. if by court order, recent deed, or inheritance, please include documentation.

BZA Application Form

SUPPORTING STATEMENT FOR A SPECIAL PERMIT

Please describe in complete detail how you meet each of the following criteria referring to the property and proposed changes or uses which are requested in your application. Attach sheets with additional information for special permits which have additional criteria, e.g.; fast food permits, comprehensive permits, etc., which must be met.

Granting the Special Permit requested for <u>63 Clarendon Ave</u>, <u>Cambridge</u>, <u>MA</u> (location) would not be a detriment to the public interest because:

A) Requirements of the Ordinance can or will be met for the following reasons:

The addition of third floor space, including installation of two dormers limited to 15 feet in length, occurring within the footprint of the existing building, will add a modest amount of needed living space for the owners and their family. The intensity of use will be reduced by the conversion from a two family to single family residence. The very small increases in FAR represented by minor changes to front and rear entrances will improve accessibility and appearance and especially in the front of the building will produce a larger setback of the front entrance from the front line of the property.

B) Traffic generated or patterns of access or egress would not cause congestion hazard, or substantial change in established neighborhood character for the following reasons:

The existing lot has two parking spaces for a two family, and that will be more than adequate to accommodate parking on site, as the use will be changing to one family. There will be no adverse impact on traffic in the neighborhood, and congestion will actually be reduced by the change of use from two family to one family. The neighborhood character will not be changed, as the exterior of the building will only be very slightly modified to change the fenestration and improve the front and rear entrances, and the footprint of the building will remain as it is.

The continued operation of or the development of adjacent uses as permitted in the Zoning

Ordinance would not be adversely affected by the nature of the proposed use for the following reasons:

The building as improved will be consistent with the size and residential character of other buildings in the neighborhood. The open space will be virtually the same as at present, and the change to single family will make operation or development of adjacent uses easier rather than more difficult due to the reduction in intensity of the use.

Nuisance or hazard would not be created to the detriment of the health, safety, and/or welfare of the occupant of the proposed use or the citizens of the City for the following reasons:

The improvements will all be constructed within the existing footprint and will only improve the comfort and safety of the occupants. The small addition on the third floor, the changes in front and rear entrances, and refenestration on the right side will blend well with and improve the design and appearance of the existing building and will fit well alongside other residential buildings in the immediate neighborhoo.

7/25/23, 9:27 AM about:blank

For other reasons, the proposed use would not impair the integrity of the district or adjoining district or otherwise derogate from the intent or purpose of this ordinance for the following reasons:

The modest improvements and enhanced appearance that the petitioner's plans make possible will help to improve the residential character of the district and will fit well with the general appearance and size of other buildings in the neighborhood.

*If you have any questions as to whether you can establish all of the applicable legal requirements, you should consult with an attorney.

BZA Application Form

DIMENSIONAL INFORMATION

Applicant: Kimberly C. Mott and Jesse A. Mott

Present Use/Occupancy: Two Family

Location: 63 Clarendon Ave, Cambridge, MA

Zone: Residence B Zone

Phone: 6178806313

Requested Use/Occupancy: Single Family

		Existing Conditions	Requested Conditions	Ordinance Requirements	
TOTAL GROSS FLOOR AREA:		2,942	3,396	2,000	(max.)
LOT AREA:		4,000	4,000	5,000	(min.)
RATIO OF GROSS FLOOR AREA TO LOT AREA: ²		.736	.849	,5	
LOT AREA OF EACH DWELLING UNIT		2,000	4,000	2,500	
SIZE OF LOT:	WIDTH	43.5	43.5	50'	
	DEPTH	92.0	92.0	N/A	
SETBACKS IN FEET:	FRONT	5.1	5.1	15	
	REAR	35.4	35.4	25'	
	LEFT SIDE	11.6	11.6	7.5 (sum of 20)	
	RIGHT SIDE	6.9	6.9	7.5 (sum of 20)	
SIZE OF BUILDING:	HEIGHT	30'3"	35	35	
	WIDTH	56.8	56.8	n/a	
	LENGTH	24.0	24.0	n/a	
RATIO OF USABLE OPEN SPACE TO LOT AREA:		59.89	59.24	40.0	
NO. OF DWELLING UNITS:		2	1	2	
NO. OF PARKING SPACES:		2	2	2	
NO. OF LOADING AREAS:		n/a	n/a	n/a	
DISTANCE TO NEAREST BLDG. ON SAME LOT		n/a	n/a	n/a	

Describe where applicable, other occupancies on the same lot, the size of adjacent buildings on same lot, and type of construction proposed, e.g; wood frame, concrete, brick, steel, etc.:

wood frame structure on concrete foundation with asphalt shingle roof

- 1. SEE CAMBRIDGE ZONING ORDINANCE ARTICLE 5.000, SECTION 5.30 (DISTRICT OF DIMENSIONAL REGULATIONS).
- 2. TOTAL GROSS FLOOR AREA (INCLUDING BASEMENT 7'-0" IN HEIGHT AND ATTIC AREAS GREATER THAN 5') DIVIDED BY LOT AREA.
- 3. OPEN SPACE SHALL NOT INCLUDE PARKING AREAS, WALKWAYS OR DRIVEWAYS AND SHALL HAVE A MINIMUM DIMENSION OF 15'.

63-65 Clarendon Residence

JESSE & KIM MOTT

63 CLARENDON AVENUE CAMBRIDGE MA. 02140





PROJECT #: 2301-6365

ARCHITECT:

CLIENTS:

GENERAL CONTRACTOR:

STRUCTURAL ENGINEER:

SAM KACHMAR

ARCHITECTS
(p)617-800-6223
www.SKA-MA.com
357 HURON AVE.

CAMBRIDGE MA, 02138

JESSE & KIM MOTT STECKEL CONSTRUCTION

SPRUHAN ENGINEERING

PROJECT NARRATIVE:

SKA

THE MOTT RESIDENCE INVOLVES THE CONVERSION OF A TWO FAMILY DWELLING INTO A SINGLE FAMILY DWELLING.

THE PROJECT INVOLVES THE INTERIOR RENOVATION OF THE HOME, WHERE THE ROOF WILL BE RAISED 56" TO THE BUILDING HEIGHT LIMIT OF 35' FROM AVERAGE GRADE TO ALLOW FOR HABITABLE SPACE AT THE 3RD FLOOR LEVEL.

ADDITIONALLY, THE PREXISTING NONCONFORMING FAR WILL INCREASE BY .113 DUE TO THE RAISING OF THE ROOF AND THE ADDTIONAL FRAMING OF ROOF AWNINGS AT THE FRONT AND REAR PORCH.

AT THE FRONT OF THE HOME, THE STAIRS WILL BE REFRAMED AND THE FENESTRATION ALONGSIDE RIGHTSIDE ELEVATION WILL BE RELOCATED.

	Sheet List PHASE 1		
V	Sheet Name		
BZA-000	COVER		
BZA-001	GENERAL NOTES		
BZA-002 SITE PLAN			
BZA-003 SITE AXON			
BZA-004 AREA PLAN			
BZA-006 STREETVIEW 1			
BZA-007	STREETVIEW 2		
BZA-008	SHADOW STUDY		
BZA-100	PLAN - LEVEL 0		
BZA-101	01 PLAN - LEVEL 1		
BZA-102 PLAN - LEVEL 2			
BZA-103 PLAN - LEVEL 3			
BZA-109 PLAN - ROOF			
BZA-200 ELEVATION EAST			
BZA-201	ELEVATION NORTH		
BZA-202	ELEVATION WEST		
BZA-203	ELEVATION SOUTH		
BZA-300	QR CODE		
BZA-301 PLOT PLAN			

BZA SUBMISSION SET

07/18/2023

BZA-001 GENERAL NOTES

ABBREVIATIONS

#	NUMBER OR POUND
**************************************	AND
<u>a, r</u>	AT
ADJ	ADJUSTABLE
AFF	ABOVE FINISH FLOOR
ALUM	ALUMINUM
APPROX	APPROXIMATELY
ARCH	ARCHITECTURAL
AVB	AIR AND VAPOR BARRIER
BD	BOARD
BIT	BITUMINOUS
BLDG	BUILDING
BSMT	BASEMENT
BTWN	BETWEEN
CF	CUBIC FEET
CI	CUBIC INCHES
CJ	CONTROL JOINT
CL	CENTERLINE
CLG	CEILING
CLR	CLEAR OR CLEARANCE
CMU	CONCRETE MASONRY UNIT
COL	COLUMN
CONC	CONCRETE
CONT	CONTINUOUS
CORR	CORRIDOR, CORRUGATED
CTR	CENTER
D	DEPTH, DEEP
DBL	DOUBLE
DEMO	DEMOLISH, DEMOLITION
DIA	DIAMETER
DIM	DIMENSION
DN	DOWN
DTL	DETAIL
DW	DISHWASHER
E	EAST
EA	EACH
EJ	EXPANSION JOINT
EL	
	ELEVATION (GRADE)
ELEC	ELECTRICAL
ELEV	ELEVATION (FACADE)
EOS	EDGE OF SLAB
EQ	EQUAL, EQUIPMENT, EQUIP
ETR	EXISTING TO REMAIN
EXG	EXISTING
EXP	
	EXPOSED
EXT	EXPOSED EXTERIOR
EXT	EXTERIOR
EXT FAB	EXTERIOR FABRICATE, FABRICATION
EXT FAB FD	EXTERIOR FABRICATE, FABRICATION FLOOR DRAIN
EXT FAB FD FF FL	EXTERIOR FABRICATE, FABRICATION FLOOR DRAIN FINISHED FLOOR FLOOR
EXT FAB FD FF FL FOW	EXTERIOR FABRICATE, FABRICATION FLOOR DRAIN FINISHED FLOOR FLOOR FACE OF WALL
EXT FAB FD FF FL FOW FT	EXTERIOR FABRICATE, FABRICATION FLOOR DRAIN FINISHED FLOOR FLOOR FACE OF WALL FEET, FOOT
EXT FAB FD FF FL FOW FT GA	EXTERIOR FABRICATE, FABRICATION FLOOR DRAIN FINISHED FLOOR FLOOR FACE OF WALL FEET, FOOT GAUGE
EXT FAB FD FF FL FOW FT GA GALV	EXTERIOR FABRICATE, FABRICATION FLOOR DRAIN FINISHED FLOOR FLOOR FACE OF WALL FEET, FOOT GAUGE GALVANIZED
EXT FAB FD FF FL FOW FT GA GALV GL	EXTERIOR FABRICATE, FABRICATION FLOOR DRAIN FINISHED FLOOR FLOOR FACE OF WALL FEET, FOOT GAUGE GALVANIZED GLASS, GLAZING, GLAZED
EXT FAB FD FF FL FOW FT GA GALV GL GWB	EXTERIOR FABRICATE, FABRICATION FLOOR DRAIN FINISHED FLOOR FLOOR FACE OF WALL FEET, FOOT GAUGE GALVANIZED GLASS, GLAZING, GLAZED GYPSUM WALLBOARD, BACKING BOARD
EXT FAB FD FF FL FOW FT GA GALV GL GWB GYP	EXTERIOR FABRICATE, FABRICATION FLOOR DRAIN FINISHED FLOOR FLOOR FACE OF WALL FEET, FOOT GAUGE GALVANIZED GLASS, GLAZING, GLAZED GYPSUM WALLBOARD, BACKING BOARD GYPSUM
EXT FAB FD FF FL FOW FT GA GALV GL GWB GYP H	EXTERIOR FABRICATE, FABRICATION FLOOR DRAIN FINISHED FLOOR FLOOR FACE OF WALL FEET, FOOT GAUGE GALVANIZED GLASS, GLAZING, GLAZED GYPSUM WALLBOARD, BACKING BOARD GYPSUM HIGH
EXT FAB FD FF FL FOW FT GA GALV GL GWB GYP	EXTERIOR FABRICATE, FABRICATION FLOOR DRAIN FINISHED FLOOR FLOOR FACE OF WALL FEET, FOOT GAUGE GALVANIZED GLASS, GLAZING, GLAZED GYPSUM WALLBOARD, BACKING BOARD GYPSUM HIGH HARDWOOD
EXT FAB FD FF FL FOW FT GA GALV GL GWB GYP H	EXTERIOR FABRICATE, FABRICATION FLOOR DRAIN FINISHED FLOOR FLOOR FACE OF WALL FEET, FOOT GAUGE GALVANIZED GLASS, GLAZING, GLAZED GYPSUM WALLBOARD, BACKING BOARD GYPSUM HIGH
EXT FAB FD FF FL FOW FT GA GALV GL GWB GYP H HDWD	EXTERIOR FABRICATE, FABRICATION FLOOR DRAIN FINISHED FLOOR FLOOR FACE OF WALL FEET, FOOT GAUGE GALVANIZED GLASS, GLAZING, GLAZED GYPSUM WALLBOARD, BACKING BOARD GYPSUM HIGH HARDWOOD HOLLOW METAL HORIZONTAL
EXT FAB FD FF FL FOW FT GA GALV GL GWB GYP H HDWD	EXTERIOR FABRICATE, FABRICATION FLOOR DRAIN FINISHED FLOOR FLOOR FACE OF WALL FEET, FOOT GAUGE GALVANIZED GLASS, GLAZING, GLAZED GYPSUM WALLBOARD, BACKING BOARD GYPSUM HIGH HARDWOOD HOLLOW METAL
EXT FAB FD FF FL FOW FT GA GALV GL GWB GYP H HDWD HM HORIZ	EXTERIOR FABRICATE, FABRICATION FLOOR DRAIN FINISHED FLOOR FLOOR FACE OF WALL FEET, FOOT GAUGE GALVANIZED GLASS, GLAZING, GLAZED GYPSUM WALLBOARD, BACKING BOARD GYPSUM HIGH HARDWOOD HOLLOW METAL HORIZONTAL
EXT FAB FD FF FL FOW FT GA GALV GL GWB GYP H HDWD HM HORIZ HVAC	EXTERIOR FABRICATE, FABRICATION FLOOR DRAIN FINISHED FLOOR FLOOR FACE OF WALL FEET, FOOT GAUGE GALVANIZED GLASS, GLAZING, GLAZED GYPSUM WALLBOARD, BACKING BOARD GYPSUM HIGH HARDWOOD HOLLOW METAL HORIZONTAL HEATING, VENTILATING & AIR CONDITIONING
EXT FAB FD FF FL FOW FT GA GALV GL GWB GYP H HDWD HM HORIZ HVAC IN	EXTERIOR FABRICATE, FABRICATION FLOOR DRAIN FINISHED FLOOR FLOOR FACE OF WALL FEET, FOOT GAUGE GALVANIZED GLASS, GLAZING, GLAZED GYPSUM WALLBOARD, BACKING BOARD GYPSUM HIGH HARDWOOD HOLLOW METAL HORIZONTAL HEATING, VENTILATING & AIR CONDITIONING INCH, INCHES


L	LENGTH
LAM	LAMINATE, LAMINATED
LB	POUND
LGMF	LIGHT GAGE METAL FRAMING
LT	LIGHT
LT WT	LIGHT WEIGHT
MAX	MAXIMUM
MDF	MEDIUM DENSITY FIBER
MECH	MECHANICAL
MED	MEDIUM
MFR	MANUFACTURER
MIN	MINIMUM
MISC	MISCELLANEOUS
MTD	MOUNTED
MTL	METAL
N	NORTH
N/A	NOT APPLICABLE
NIC	NOT IN CONTRACT
NOM	NOMINAL
NTS	NOT TO SCALE
OC	ON CENTER
OD	OUTSIDE DIAMETER
OH	OPPOSITE HAND
OPP	OPPOSITE HAND
OSB	ORIENTED STRANDBOARD
OVHD	OVERHEAD
OZ	OUNCE (S)
PATT	PATTERN (ED)
PERF	PERFORATED
PERP	PERPENDICULAR
PLAM	PLASTIC LAMINATE
PLYWD	PLYWOOD
PNT	PAINT, PAINTED
PR	PAIR
PREFAB	PREFABRICATE, PREFABRICATED
QTY	QUANTITY
RAD	RADIUS
RAD RBR	RADIUS RUBBER
RAD RBR RD	RADIUS RUBBER ROOF DRAIN
RAD RBR RD REF	RADIUS RUBBER ROOF DRAIN REFERENCE
RAD RBR RD REF REFR	RADIUS RUBBER ROOF DRAIN REFERENCE REFRIGERATE, REFRIGERATOR
RAD RBR RD REF REFR REINF	RADIUS RUBBER ROOF DRAIN REFERENCE REFRIGERATE, REFRIGERATOR REINFORCE, REINFORCED
RAD RBR RD REF REFR REINF REQ	RADIUS RUBBER ROOF DRAIN REFERENCE REFRIGERATE, REFRIGERATOR REINFORCE, REINFORCED REQUIRE
RAD RBR RD REF REFR REINF	RADIUS RUBBER ROOF DRAIN REFERENCE REFRIGERATE, REFRIGERATOR REINFORCE, REINFORCED REQUIRE REVISION, REVISE, REVISED
RAD RBR RD REF REFR REINF REQ	RADIUS RUBBER ROOF DRAIN REFERENCE REFRIGERATE, REFRIGERATOR REINFORCE, REINFORCED REQUIRE REVISION, REVISE, REVISED ROOM
RAD RBR RD REF REFR REINF REQ REV	RADIUS RUBBER ROOF DRAIN REFERENCE REFRIGERATE, REFRIGERATOR REINFORCE, REINFORCED REQUIRE REVISION, REVISE, REVISED
RAD RBR RD REF REFR REINF REQ REV RM RO S	RADIUS RUBBER ROOF DRAIN REFERENCE REFRIGERATE, REFRIGERATOR REINFORCE, REINFORCED REQUIRE REVISION, REVISE, REVISED ROOM
RAD RBR RD REF REFR REINF REQ REV RM RO	RADIUS RUBBER ROOF DRAIN REFERENCE REFRIGERATE, REFRIGERATOR REINFORCE, REINFORCED REQUIRE REVISION, REVISE, REVISED ROOM ROUGH OPENING
RAD RBR RD REF REFR REINF REQ REV RM RO S	RADIUS RUBBER ROOF DRAIN REFERENCE REFRIGERATE, REFRIGERATOR REINFORCE, REINFORCED REQUIRE REVISION, REVISE, REVISED ROOM ROUGH OPENING SOUTH
RAD RBR RD REF REFR REINF REQ REV RM RO S SCHED	RADIUS RUBBER ROOF DRAIN REFERENCE REFRIGERATE, REFRIGERATOR REINFORCE, REINFORCED REQUIRE REVISION, REVISE, REVISED ROOM ROUGH OPENING SOUTH SCHEDULE
RAD RBR RD REF REFR REINF REQ REV RM RO S SCHED	RADIUS RUBBER ROOF DRAIN REFERENCE REFRIGERATE, REFRIGERATOR REINFORCE, REINFORCED REQUIRE REVISION, REVISE, REVISED ROOM ROUGH OPENING SOUTH SCHEDULE SQUARE FEET
RAD RBR RD REF REFR REINF REQ REV RM RO S SCHED SF SI	RADIUS RUBBER ROOF DRAIN REFERENCE REFRIGERATE, REFRIGERATOR REINFORCE, REINFORCED REQUIRE REVISION, REVISE, REVISED ROOM ROUGH OPENING SOUTH SCHEDULE SQUARE FEET SQUARE INCHES
RAD RBR RD REF REFR REINF REQ REV RM RO S SCHED SF SI SIM	RADIUS RUBBER ROOF DRAIN REFERENCE REFRIGERATE, REFRIGERATOR REINFORCE, REINFORCED REQUIRE REVISION, REVISE, REVISED ROOM ROUGH OPENING SOUTH SCHEDULE SQUARE FEET SQUARE INCHES SIMILAR
RAD RBR RD REF REFR REINF REQ REV RM RO S SCHED SF SI SIM SPEC	RADIUS RUBBER ROOF DRAIN REFERENCE REFRIGERATE, REFRIGERATOR REINFORCE, REINFORCED REQUIRE REVISION, REVISE, REVISED ROOM ROUGH OPENING SOUTH SCHEDULE SQUARE FEET SQUARE INCHES SIMILAR SPECIFICATION
RAD RBR RD REF REFR REINF REQ REV RM RO S SCHED SF SI SIM SPEC SQ	RADIUS RUBBER ROOF DRAIN REFERENCE REFRIGERATE, REFRIGERATOR REINFORCE, REINFORCED REQUIRE REVISION, REVISE, REVISED ROOM ROUGH OPENING SOUTH SCHEDULE SQUARE FEET SQUARE INCHES SIMILAR SPECIFICATION SQUARE
RAD RBR RD REF REFR REINF REQ REV RM RO S SCHED SF SI SIM SPEC SQ SS, SST	RADIUS RUBBER ROOF DRAIN REFERENCE REFRIGERATE, REFRIGERATOR REINFORCE, REINFORCED REQUIRE REVISION, REVISE, REVISED ROOM ROUGH OPENING SOUTH SCHEDULE SQUARE FEET SQUARE INCHES SIMILAR SPECIFICATION SQUARE STAINLESS STEEL
RAD RBR RD REF REFR REINF REQ REV RM RO S SCHED SF SI SIM SPEC SQ SS, SST STC	RADIUS RUBBER ROOF DRAIN REFERENCE REFRIGERATE, REFRIGERATOR REINFORCE, REINFORCED REQUIRE REVISION, REVISE, REVISED ROOM ROUGH OPENING SOUTH SCHEDULE SQUARE FEET SQUARE INCHES SIMILAR SPECIFICATION SQUARE STAINLESS STEEL SOUND TRANSMISSION CLASS
RAD RBR RD REF REFR REINF REQ REV RM RO S SCHED SF SI SIM SPEC SQ SS, SST STC STL	RADIUS RUBBER ROOF DRAIN REFERENCE REFRIGERATE, REFRIGERATOR REINFORCE, REINFORCED REQUIRE REVISION, REVISE, REVISED ROOM ROUGH OPENING SOUTH SCHEDULE SQUARE FEET SQUARE INCHES SIMILAR SPECIFICATION SQUARE STAINLESS STEEL SOUND TRANSMISSION CLASS STEEL
RAD RBR RD REF REFR REINF REQ REV RM RO S SCHED SF SI SIM SPEC SQ SS, SST STC STL STOR	RADIUS RUBBER ROOF DRAIN REFERENCE REFRIGERATE, REFRIGERATOR REINFORCE, REINFORCED REQUIRE REVISION, REVISE, REVISED ROOM ROUGH OPENING SOUTH SCHEDULE SQUARE FEET SQUARE INCHES SIMILAR SPECIFICATION SQUARE STAINLESS STEEL SOUND TRANSMISSION CLASS STEEL STORAGE
RAD RBR RD REF REFR REINF REQ REV RM RO S SCHED SF SI SIM SPEC SQ SS, SST STC STL STOR STR T.O.	RADIUS RUBBER ROOF DRAIN REFERENCE REFRIGERATE, REFRIGERATOR REINFORCE, REINFORCED REQUIRE REVISION, REVISE, REVISED ROOM ROUGH OPENING SOUTH SCHEDULE SQUARE FEET SQUARE INCHES SIMILAR SPECIFICATION SQUARE STAINLESS STEEL SOUND TRANSMISSION CLASS STEEL STORAGE STAIR TOP OF
RAD RBR RD REF REFR REINF REQ REV RM RO S SCHED SF SI SIM SPEC SQ SS, SST STC STL STOR STR T.O. U.O.	RADIUS RUBBER ROOF DRAIN REFERENCE REFRIGERATE, REFRIGERATOR REINFORCE, REINFORCED REQUIRE REVISION, REVISE, REVISED ROOM ROUGH OPENING SOUTH SCHEDULE SQUARE FEET SQUARE INCHES SIMILAR SPECIFICATION SQUARE STAINLESS STEEL SOUND TRANSMISSION CLASS STEEL STORAGE STAIR TOP OF UNDERSIDE OF
RAD RBR RD REF REFR REINF REQ REV RM RO S SCHED SF SI SIM SPEC SQ SS, SST STC STL STOR STR T.O. U.O. UON	RADIUS RUBBER ROOF DRAIN REFERENCE REFRIGERATE, REFRIGERATOR REINFORCE, REINFORCED REQUIRE REVISION, REVISE, REVISED ROOM ROUGH OPENING SOUTH SCHEDULE SQUARE FEET SQUARE INCHES SIMILAR SPECIFICATION SQUARE STAINLESS STEEL SOUND TRANSMISSION CLASS STEEL STORAGE STAIR TOP OF UNDERSIDE OF UNLESS OTHERWISE NOTED
RAD RBR RD REF REFR REINF REQ REV RM RO S SCHED SF SI SIM SPEC SQ SS, SST STC STL STOR STR T.O. U.O. UON WD	RADIUS RUBBER ROOF DRAIN REFERENCE REFRIGERATE, REFRIGERATOR REINFORCE, REINFORCED REQUIRE REVISION, REVISE, REVISED ROOM ROUGH OPENING SOUTH SCHEDULE SQUARE FEET SQUARE INCHES SIMILAR SPECIFICATION SQUARE STAINLESS STEEL SOUND TRANSMISSION CLASS STEEL STORAGE STAIR TOP OF UNDERSIDE OF UNLESS OTHERWISE NOTED WOOD
RAD RBR RD REF REFR REINF REQ REV RM RO S SCHED SF SI SIM SPEC SQ SS, SST STC STL STOR STR T.O. U.O. UON WD WT	RADIUS RUBBER ROOF DRAIN REFERENCE REFRIGERATE, REFRIGERATOR REINFORCE, REINFORCED REQUIRE REVISION, REVISE, REVISED ROOM ROUGH OPENING SOUTH SCHEDULE SQUARE FEET SQUARE INCHES SIMILAR SPECIFICATION SQUARE STAINLESS STEEL SOUND TRANSMISSION CLASS STEEL STORAGE STAIR TOP OF UNDERSIDE OF UNLESS OTHERWISE NOTED WOOD WEIGHT
RAD RBR RD REF REFR REINF REQ REV RM RO S SCHED SF SI SIM SPEC SQ SS, SST STC STL STOR STR T.O. U.O. UON WD	RADIUS RUBBER ROOF DRAIN REFERENCE REFRIGERATE, REFRIGERATOR REINFORCE, REINFORCED REQUIRE REVISION, REVISE, REVISED ROOM ROUGH OPENING SOUTH SCHEDULE SQUARE FEET SQUARE INCHES SIMILAR SPECIFICATION SQUARE STAINLESS STEEL SOUND TRANSMISSION CLASS STEEL STORAGE STAIR TOP OF UNDERSIDE OF UNLESS OTHERWISE NOTED WOOD

	2 - MATERIALS Copy 1 1/2" = 1'-0"	2 16 6 16
		24 FEP (x2)
Map-Lot 184-15	45	FUS 45 BAS UBM
Map-Lot 184-48 Map-Lot 184-48 Map-Lot 184-48 Map-Lot 184-48 Map-Lot 184-188		24 6 12 FEP (x2

MATERIALS

	EARTH
	CONCRETE
	GRAVEL
	SAND
	GYPSUM BOARD OR SHEATHING
	MASONRY - BRICK
	MASONRY - CONCRETE BLOCK
	WOOD - FINISH - END GRAIN
	WOOD - FINISH - FACE
	WOOD - ROUGH - BLOCKING (CONTINUOUS MEMBERS)
	WOOD - ROUGH - BLOCKING (INTERMEDIATE MEMBERS)
	INSULATION - RIGID
	INSULATION - BATT OR MINERAL WOOL
	ACOUSTIC TILE, PANEL, OR PLANK
	PLYWOOD
	CUT STONE
	PARTICLE BOARD OR FIBERBOARD
•	

SYMBOLS

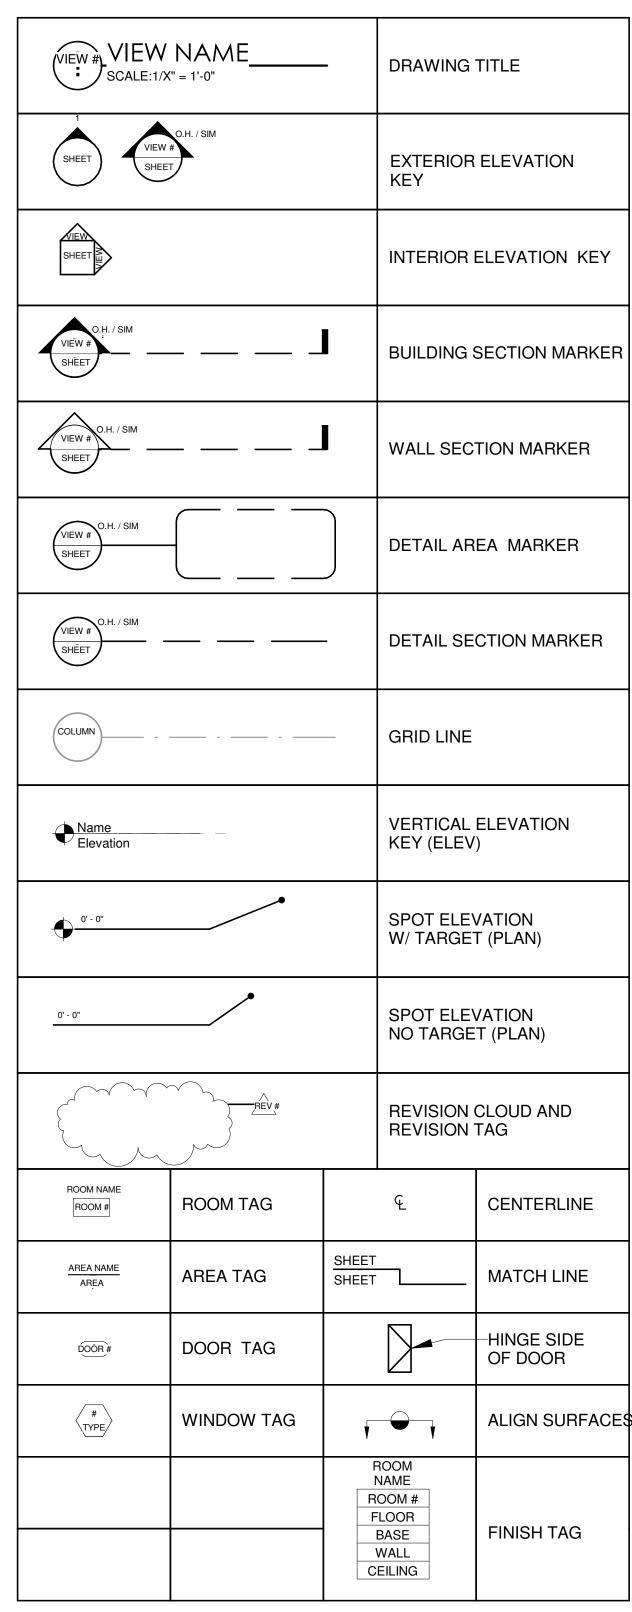

3 - SYMBOLS Copy 2 1 1/2" = 1'-0"

GENERAL NOTES

- ALL WORK SHALL BE CONSIDERED NEW, UNLESS OTHERWISE INDICATED.
- 2. DO NOT SCALE DRAWINGS
- 3. VERIFY DIMENSIONS, GRADES, BOUNDARIES, AND CONSTRUCTION AND IMMEDIATELY REPORT ANY DISCREPANCIES BEFORE PROCEEDING WITH THE WORK.
- 4. TO THE EXTENT PRACTICABLE, VERIFY DIMENSIONS AND FIELD CONDITIONS AT THE SITE PRIOR TO THE BID SUBMISSION. CONFLICTS, OMISSIONS AND DISCREPANCIES WITHIN THE CONTRACT DOCUMENTS SHALL BE REPORTED IN WRITING TO THE ARCHITECT, IN ACCORDANCE WITH THE CONTRACT DOCUMENTS, PRIOR TO THE BID SUBMISSION. THE CONTRACTOR WARRANTS, BY TENDERING HIS BID, THAT THE WORK IS BUILDABLE AS SHOWN.
- 5. LAYOUT ALL WORK WITHIN THE CONFINES OF EXISTING CONSTRUCTION AND RESOLVE DISCREPANCIES PRIOR TO INITIATION OF NEW WORK.
- 6. ARCHITECT IS NOT RESPONSIBLE FOR CONSTRUCTION THAT IS STARTED PRIOR TO PERMIT BEING ISSUED.
- 7. DIMENSIONS, NOTES, FINISHES AND FIXTURES SHOWN ON TYPICAL FLOOR PLANS, SECTION OR DETAILS SHALL APPLY TO SIMILAR, SYMMETRICAL OR OPPOSITE HAND PLANS SECTIONS OR DETAILS, UNLESS NOTED OTHERWISE.
- 8. TYPICAL OR "TYP" SHALL MEAN THAT THE CONDITION IS REPRESENTATIVE FOR SIMILAR CONDITIONS THROUGHOUT, UNLESS NOTED OTHERWISE. DETAILS ARE USUALLY KEYED AND NOTED "TYP" ONLY ONE TIME, WHEN THEY FIRST OCCUR.
- 9. IMMEDIATELY NOTIFY THE ARCHITECT IN WRITING OF ANY DISCREPANCIES BETWEEN PROJECT MANUAL, LARGE SCALE DRAWINGS, SMALL SCALE DRAWINGS AND DETAILS. THE CONTRACTOR SHALL NOT PROCEED WITH AFFECTED WORK UNTIL ARCHITECT PROVIDES CLARIFICATION.
- 10. PARTITIONS ARE DIMENSIONED FROM FINISHED FACE TO FINISHED FACE UNLESS OTHERWISE NOTED. DIMENSIONS TO MASONRY ARE TO ACTUAL FINISHED FACE, UNLESS OTHERWISE NOTED.
- 11. VERIFY THAT DRAWINGS ARE THE LATEST ISSUE PRIOR TO COMMENCING CONSTRUCTION. THE GENERAL CONTRACTOR SHALL BE RESPONSIBLE FOR COMMUNICATING AND DISTRIBUTING ALL CONSTRUCTION DOCUMENT UPDATES TO ALL TRADES.
- 12. WORK SHALL CONFORM TO THE REQUIREMENTS OF APPLICABLE STATE, FEDERAL AND CITY/COUNTY CODES. STATE AND FEDERAL CODES ARE TO TAKE PRECEDENCE OVER THE DRAWINGS AND SPECIFICATIONS. IF ANY DISCREPANCY IS NOTED, IMMEDIATELY INFORM THE ARCHITECT, PRIOR TO PROCEEDING WITH THE WORK.
- 13. FILE, OBTAIN AND PAY FEES FOR BUILDING DEPARTMENT PERMITS, CONTROLLED INSPECTIONS, OTHER AGENCY APPROVALS AND PERMITS WHERE REQUIRED, AND FINAL WRITE-OFFS FOR PROJECT COMPLETION. COPIES OF TRANSACTIONS SHALL BE FORWARDED TO THE OWNER OR OWNER'S REPRESENTATIVE.
- 14. EXECUTE INSPECTIONS NECESSARY TO OBTAIN A CERTIFICATE OF OCCUPANCY.
- 15. WORK AREA SHALL BE MAINTAINED, CLEAN AND FREE OF DEBRIS AT ALL TIMES.
- 16. PATCH ALL SURFACES TO MATCH ADJACENT IN A MANNER SUITABLE TO RECEIVE FINISHES.
- 17. PATCH, REPAIR AND FINISH ALL SURFACES IN AREAS OUTSIDE OF THE EXISTING SCOPE THAT ARE DISTURBED AS A RESULT OF THE WORK.
- 18. COORDINATE AND PROVIDE BLOCKING AND STRAPPING WITHIN PARTITIONS FOR MILLWORK AND OTHER WALL ATTACHED ITEMS.
- 19. APPLY, INSTALL, CONNECT, CLEAN AND/OR CONDITION MANUFACTURED ARTICLES, MATERIALS AND/OR EQUIPMENT PER MANUFACTURER'S INSTRUCTIONS. IN CASE OF CONFLICT BETWEEN MANUFACTURER'S INSTRUCTIONS AND THE CONTRACT DOCUMENTS, THE CONTRACTOR SHALL OBTAIN WRITTEN CLARIFICATION FROM THE ARCHITECT BEFORE PROCEEDING.
- 20. GLASS 18" OR LESS FROM FLOOR LINE OR ADJACENT TO A DOOR SWING SHALL BE SAFETY GLASS AS REQUIRED BY APPLICABLE CODE(S). THE CONTRACTOR SHALL BE RESPONSIBLE FOR PROVIDING." SAFETY GLASS, UNLESS OTHERWISE NOTED, TO COMPLY WITH BUILDING AND LIFE SAFETY CODES, INDUSTRY STANDARDS AND OTHER APPLICABLE FEDERAL AND STATE CODES.
- 21. FLASHING AT EXTERIOR WALLS SHALL BE INSTALLED WITH SEALED JOINTS, SEALED PENETRATIONS AND ENDS TURNED UP. IT SHALL BE FABRICATED AND INSTALLED TO ENSURE THAT MOISTURE IN WALLS WILL BE DIRECTED TO WICKS AND WEEP HOLES.
- 22. COORDINATE ALL DIMENSIONS CONCERNING
 DOORS/PANELS/WINDOWS, STAIRS AND THEIR OPENINGS WITH
 PRODUCT MANUFACTURERS PRIOR TO FABRICATION AND
- CONSTRUCTION.

 23. PROVIDE WEATHERSTRIP AT EXTERIOR DOORS.

24. PROVIDE FLASHING AND/OR SEALANT AT OPENINGS IN ROOF OR

- WALLS TO ENSURE A WEATHERTIGHT BUILDING.

 25. LOCATE THERMOSTATS ADJACENT TO SWITCH PLATES WHERE POSSIBLE. VERIFY LOCATION WITH THE ARCHITECT PRIOR TO INSTALLATION TO AVOID CONFLICTS WITH BUILT-INS OR SYSTEMS FURNITURE OR DESIGN ELEMENTS.
- 26. ALIGN OUTLETS, WALL SWITCHES, TEL-DATA JACKS, ETC., INDICATED TO BE MOUNTED AT NEAR EQUIVALENT ELEVATIONS.
- 27. ALL DOORS SHALL BE LOCATED 6" OFF THE ADJACENT PARTITION, OR ONE MASONRY COURSE AT CMU PARTITIONS, UNLESS NOTED OTHERWISE.
- 28. DURING DEMOLITION AND CONSTRUCTION PROTECT ALL EXISTING FINISHES TO REMAIN.
- 29 ALL WOOD SHALL BE ESC C
- 29. ALL WOOD SHALL BE FSC CERTIFIED.30. ALL WOOD FRAMING SIZES ARE BASED ON SPF-SS
- 30. ALL WOOD FRAMING SIZES ARE BASED ON SPF-SS
 31. ALL WOOD IN CONTACT WITH CONCRETE OR MASONRY SHALL BE PRESSURE TREATED (P.T.).
- 32. CORRECT ALL DEFECTS FOUND IN EXISTING BUILDING WHICH INTERFERE WITH NEW CONSTRUCTION. THIS INCLUDES BUT IS NOT LIMITED TO UNEVEN SURFACES AND FINISHES AT GWB.

1 - GENERAL NOTES Copy 2 1 1/2" = 1'-0"



SAM KACHMAR ARCHITECTS

(p) 617-800-6223 www.SKA-MA.com

357 HURON AVE.
CAMBRIDGE MA, 02138

REGISTRATIONS:

NOT FOR CONSTRUCTION

eneral notes

55 Clarendon Residenc

VENUE 02140

CLARENDO AMBRIDGE

63 C/

CONSTRUCTION
Project Status DOCUMENTS
Project number 2301-6365
Date 07/18/2023
Drawn by Author


Checked by Checker

BZA-001


Scale

1 1/2" = 1'-0"

2023 6:06:23 PM

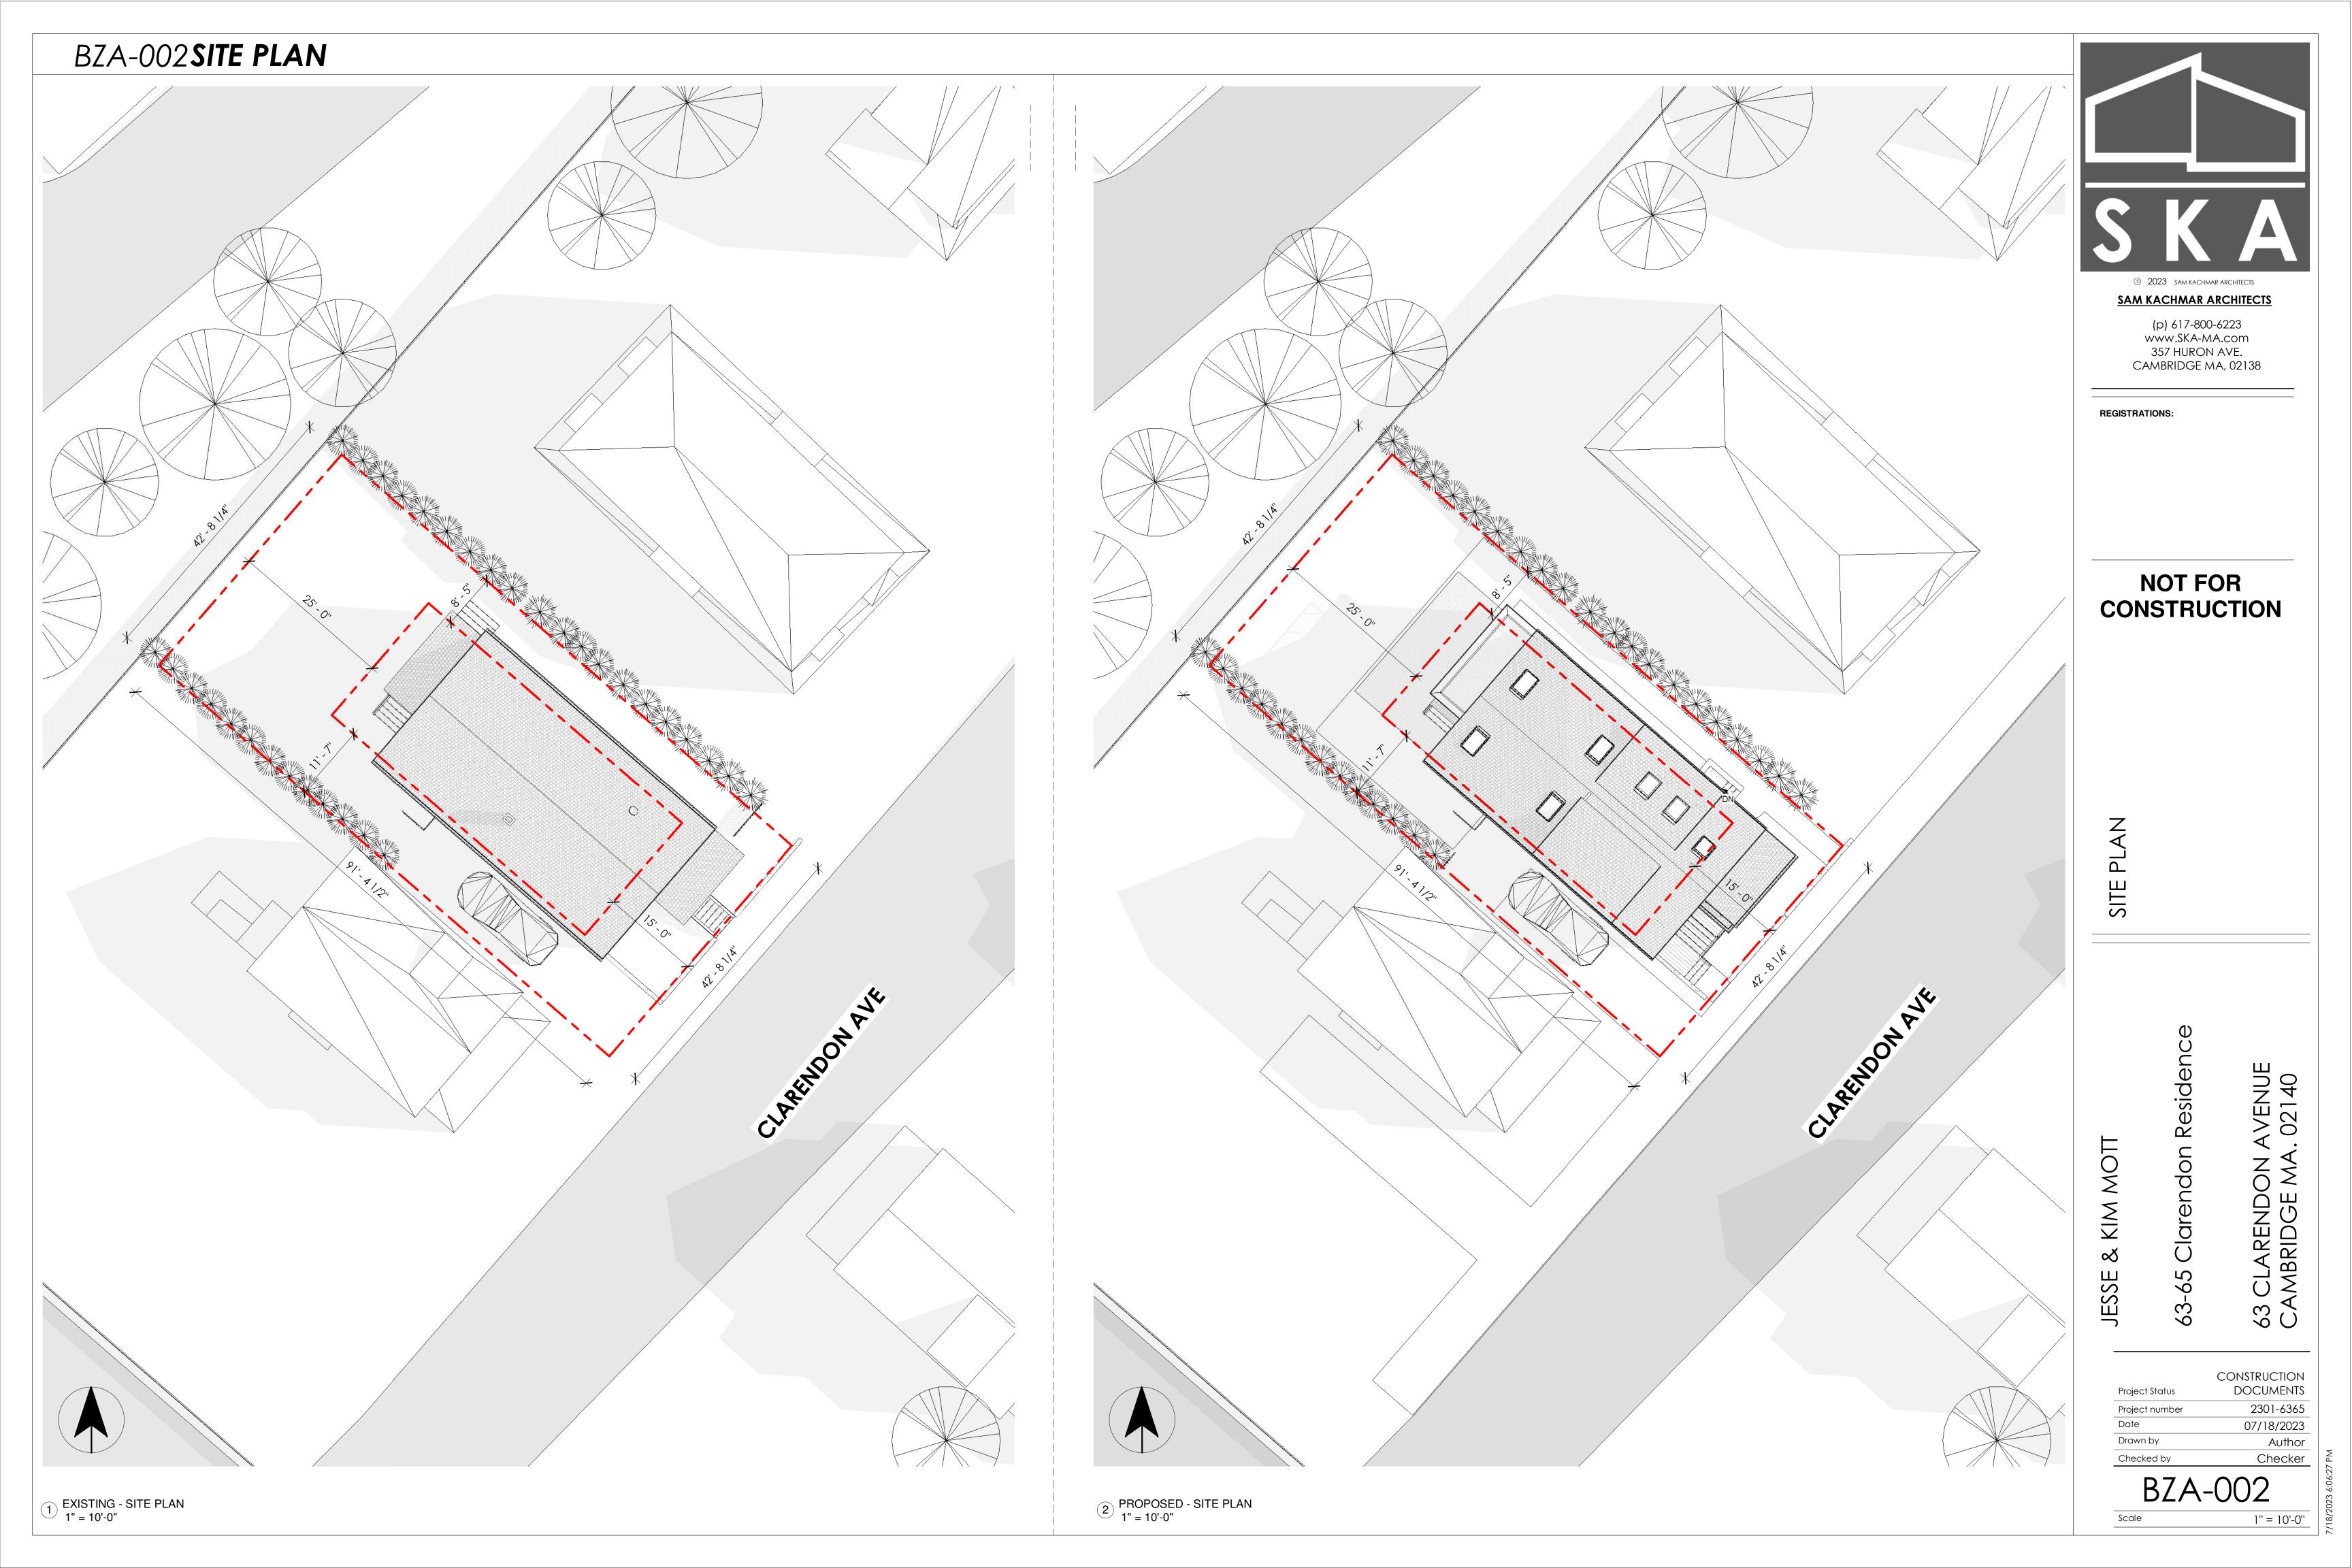

BZA-004**AREA PLAN**

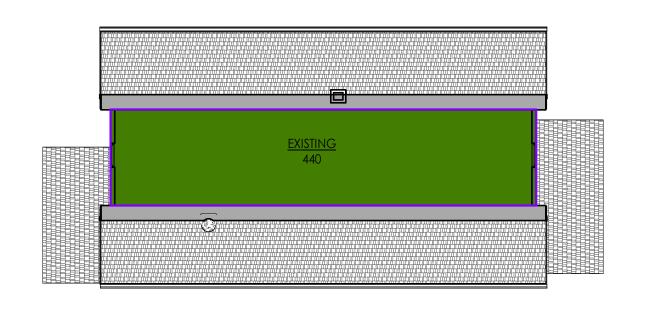

4 EXISTING - AREA PLAN - LEVEL 3 1" = 10'-0"

3 EXISTING - AREA PLAN - LEVEL 2 1" = 10'-0"

2 EXISTING - AREA PLAN - LEVEL 1 1" = 10'-0"

EXISTING


EXISTING FAR

EXISTING FAR

EXISTING

EXISTING


EXISTING FAR

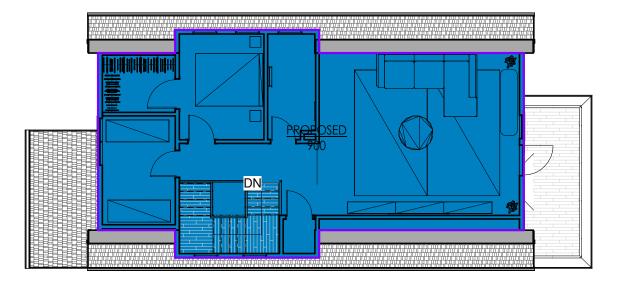

8 PROPOSED - AREA PLAN - LEVEL 3 1" = 10'-0"

PROPOSED FAR

PROPOSED

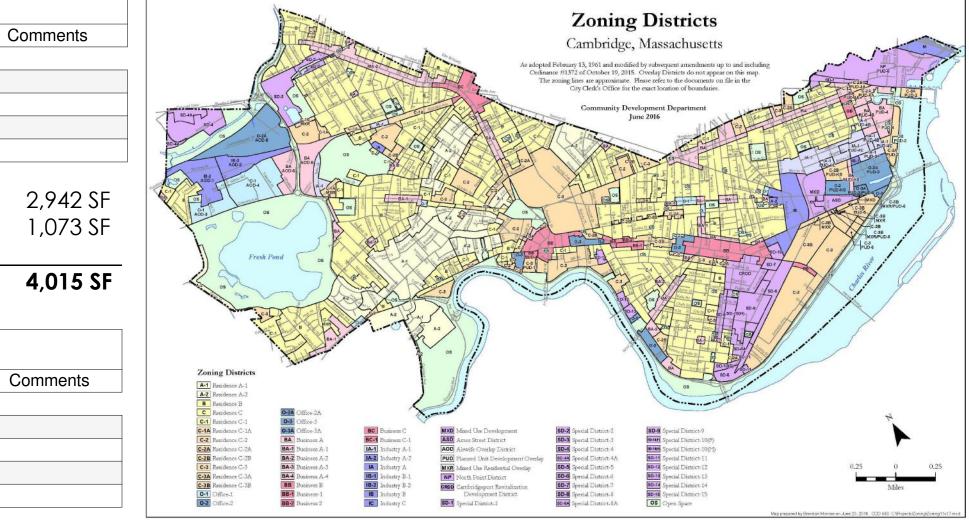

7 PROPOSED - AREA PLAN - LEVEL 2 1" = 10'-0"

6 PROPOSED - AREA PLAN - LEVEL 1 1" = 10'-0"

PROPOSED FAR

PROPOSED

PROPOSED FAR

PROPOSED

LOT SIZE: 4,000 SQ FT REQUIRED OPEN SPACE (MIN):

40.00% EXISTING OPEN SPACE: 59.89% PROPOSED OPEN SPACE: 59.24%

Existing FAR

1073 SF

1249 SF

1249 SF

444 SF

Proposed FAR

1073 SF

1249 SF

1249 SF

SINGLE- & TWO-FAMILY DETACHED TOWNHOUSE DWELLINGS

898 SF 4469 SF

Area

3,396 SF 1,073 SF

4,469 SF

Level

EXISTING ABOVE GRADE FAR:

* BASEMENT AREA EXEMPT

PROPOSED ABOVE GRADE FAR:

* BASEMENT AREA EXEMPT

PROPOSED BASEMENT FAR*:

ZONE DISTRICT - RESIDENCE B:

OPEN SPACE CALCULATIONS

TOTAL PROPOSED FAR:

EIXSTING BASEMENT FAR*:

TOTAL EXISTING FAR:

Level

EXISTING LEVEL 0

EXISTING LEVEL 1

EXISTING LEVEL 2

EXISTING LEVEL 3

EXISTING LEVEL 0

EXISTING LEVEL 1

EXISTING LEVEL 2

EXISTING LEVEL 3

PROPOSED DECREASED OPEN: 00.65%

FAR CALCULATION

REQUIRED FAR: 0.500 0.736 EXISTING FAR: PROPOSED FAR: 0.849

PROPOSED INCREASE FAR: 0.113 **SET BACKS**

REQUIRED FRONT YARD SETBACK: 15' **EXISTING SETBACK:** 5.1' PROPOSED SETBACK:

REQUIRED LEFT SIDE YARD SETBACK: 7.5' MIN (SUM OF 20)

25'

EXISTING SETBACK: 11.6' PROPOSED SETBACK: 11.6'

REQUIRED RIGHT SIDE YARD SETBACK: 7.5' MIN (SUM OF 20) **EXISTING SETBACK:** 6.9'

PROPOSED SETBACK: 25' **REQUIRED REAR YARD SETBACK:** EXISTING SETBACK:


BUILDING HEIGHT

REQUIRED BUILDING HEIGHT: 35' 30.3' **EXISTING HEIGHT:** PROPOSED HEIGHT: 35.0'

PROPOSED INCREASE

PROPOSED SETBACK:

IN BUILDING HEIGHT: 4.7' 35' - 4 13/16" LOT SIZE 4000 25' - 0"

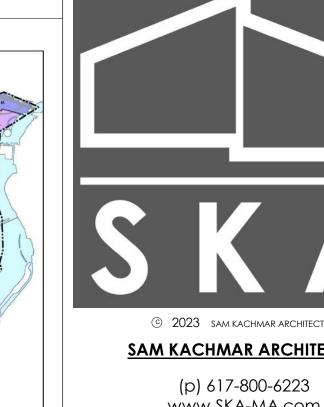

SAM KACHMAR ARCHITECTS

www.SKA-MA.com 357 HURON AVE. CAMBRIDGE MA, 02138

REGISTRATIONS:

NOT FOR CONSTRUCTION

RE,

KIM MOT

JESSE

Scale

AVENUE \. 02140 63 CLARENDON CAMBRIDGE MA

Residence


Clarendon

92


CONSTRUCTION **DOCUMENTS** Project Status 2301-6365 Project number Date 07/18/2023 Author Checker

Checked by BZA-004

As indicated

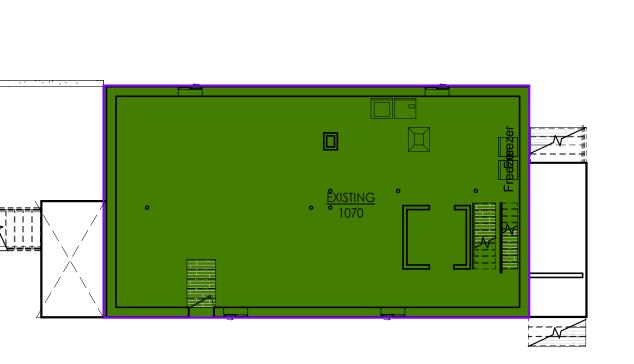


EXISTING FAR 1) EXISTING - AREA PLAN - LEVEL 0 1" = 10'-0" EXISTING

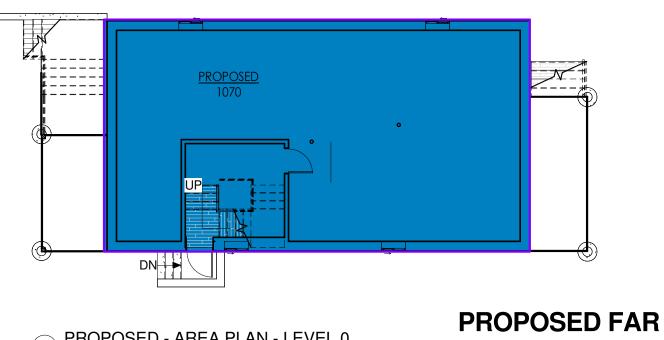

5 PROPOSED - AREA PLAN - LEVEL 0 1" = 10'-0"


PROPOSED

9 PROPOSED - LOT PLAN 1/8" = 1'-0"

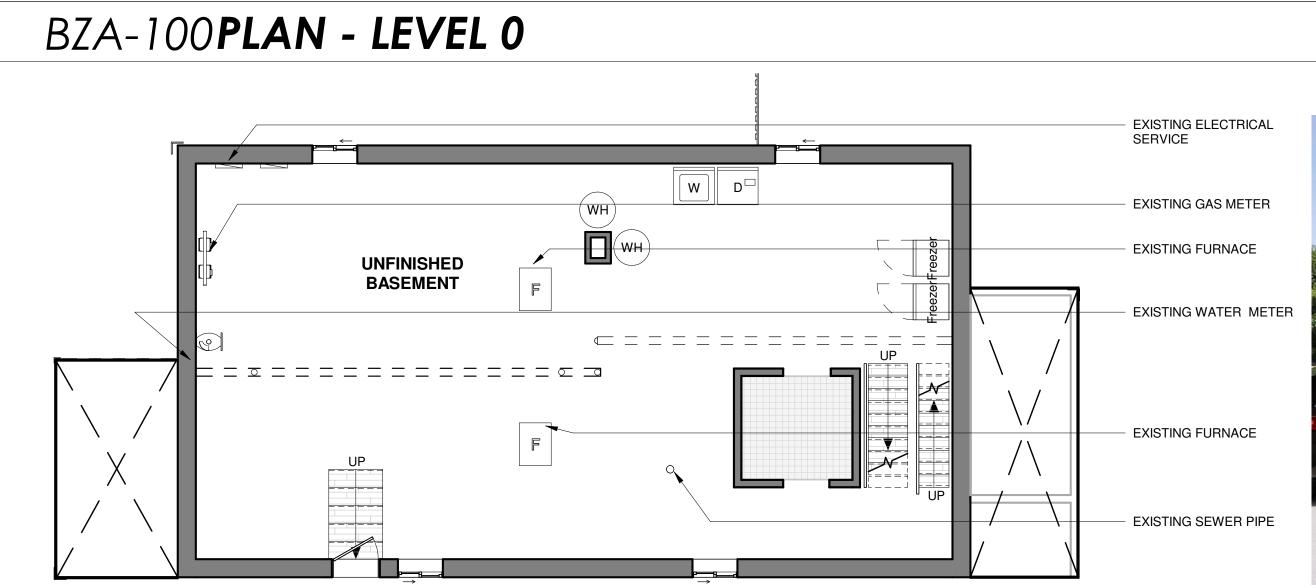

1 EXISTING - LEVEL 0 3/16" = 1'-0"



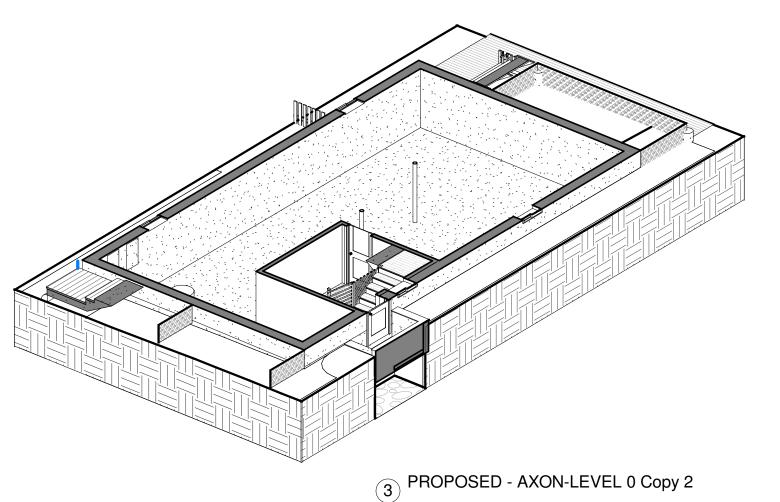



SAM KACHMAR ARCHITECTS

(p) 617-800-6223 www.SKA-MA.com 357 HURON AVE. CAMBRIDGE MA, 02138

REGISTRATIONS:

NOT FOR CONSTRUCTION

KIM MOTT

JESSE


99

AVENUE \. 02140

63 CLARENDON A CAMBRIDGE MA. CONSTRUCTION DOCUMENTS Project Status 2301-6365 Project number Date 07/18/2023 Drawn by Author

Checker Checked by Scale As indicated

LIMITED WORK AT THIS LEVEL

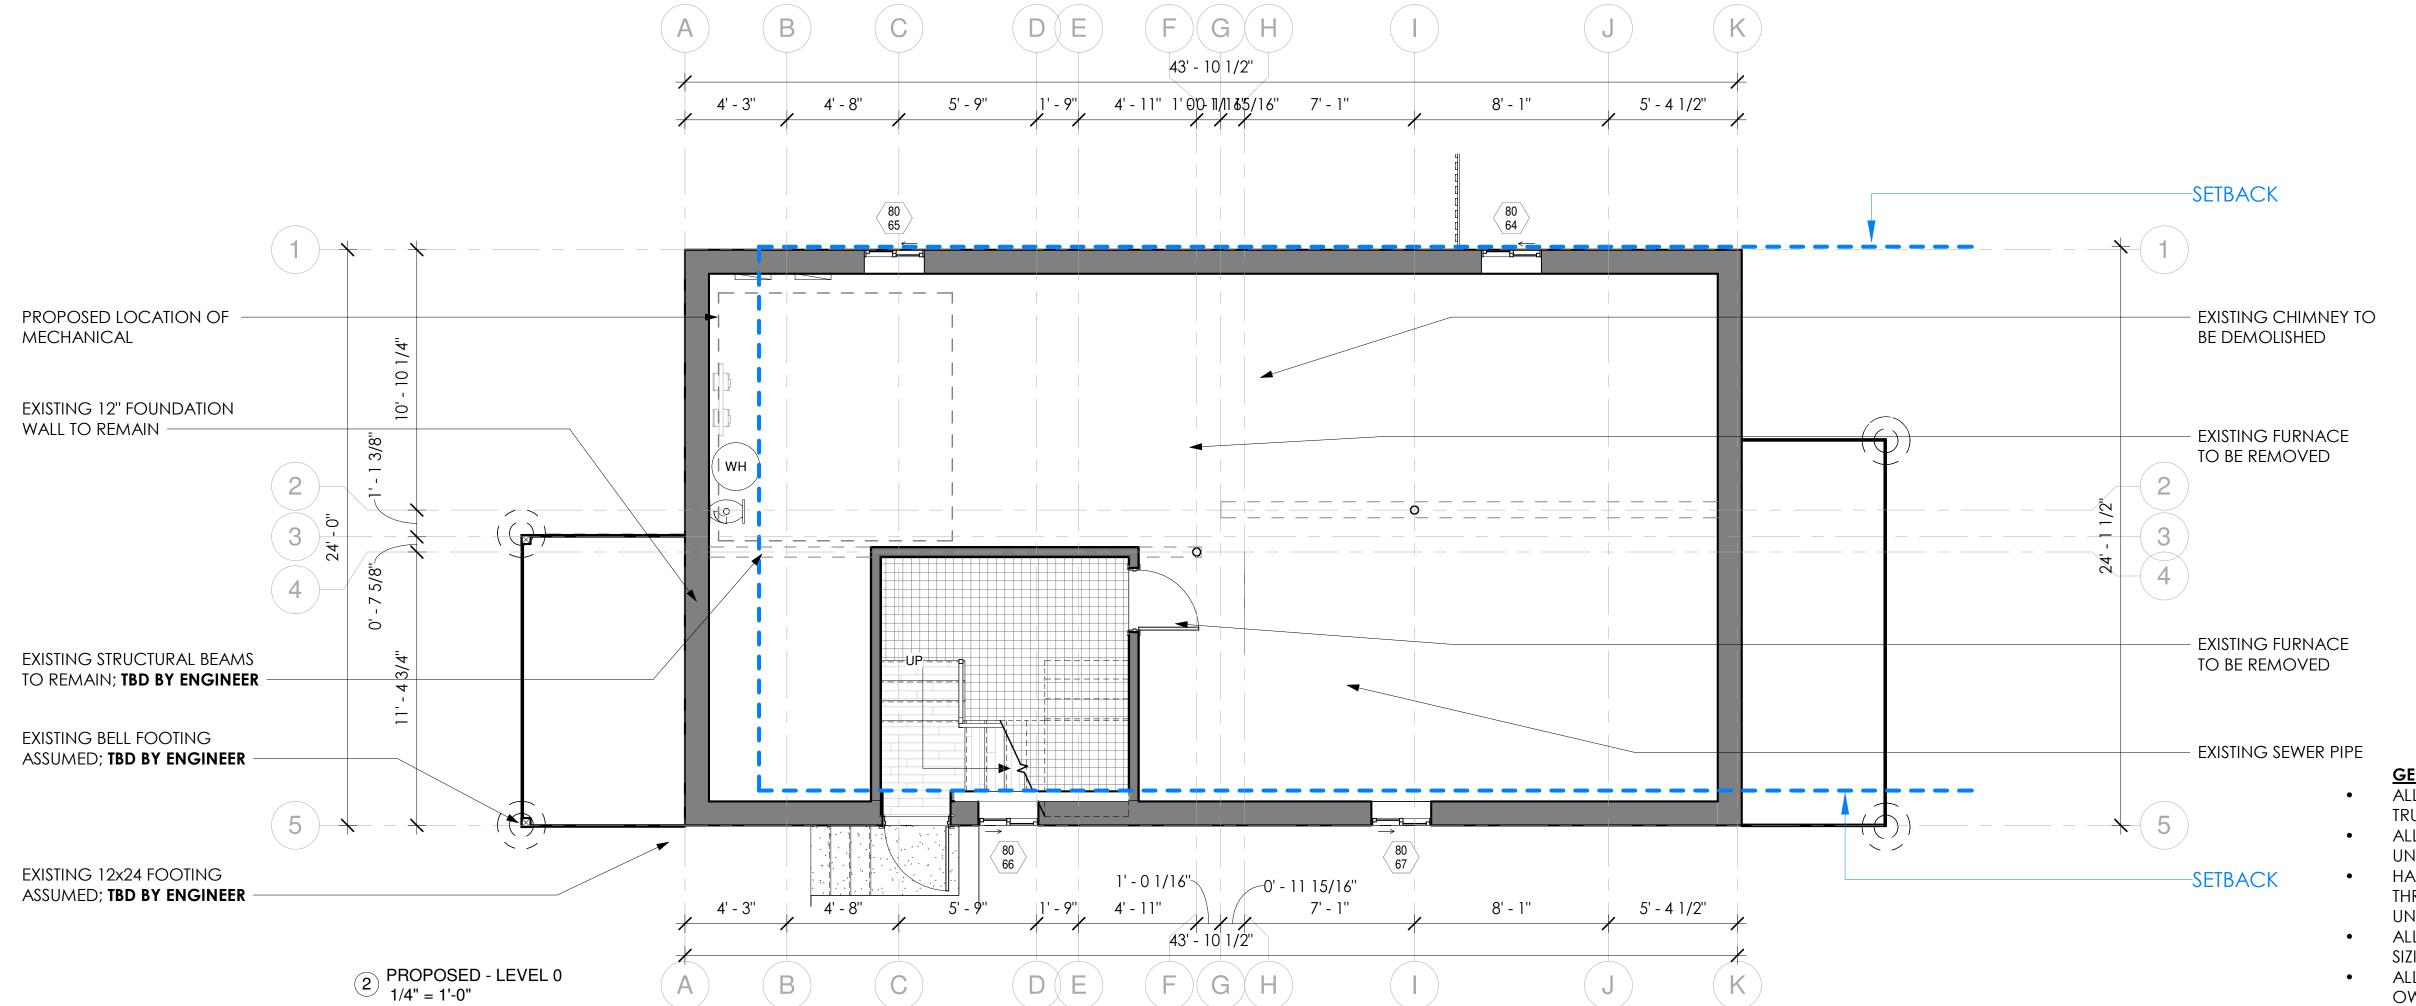


GENERAL NOTE:

 ALL INTERIOR DOORS TO BE TRUSTILE UNLESS NOTED OTHERWISE ALL WINDOWS TO BE SALVAGED UNLESS NOTED OTHERWISE


 HARDWOOD FLOORING THROUGHOUT TO BE 2" RED OAK UNLESS NOTED OTHERWISE ALL CABINETRY TO BE STANDARD

SIZING UNLESS NOTED OTHERWISE ALL FURNITURE TO BE PROVIDED BY OWNER UNLESS NOTED OTHERWISE SEE STRUCUTRAL DRAWINGS FOR

STRUCTURAL SCOPE. TO BE DETERMINED BY STRUCTURAL ENGINEER

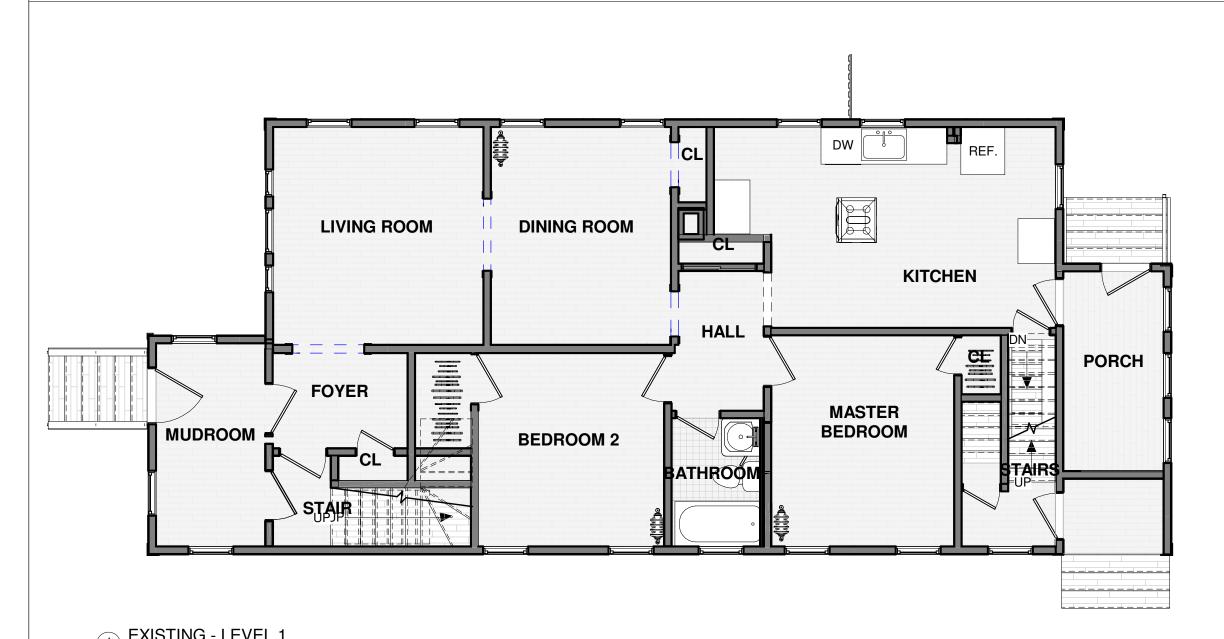



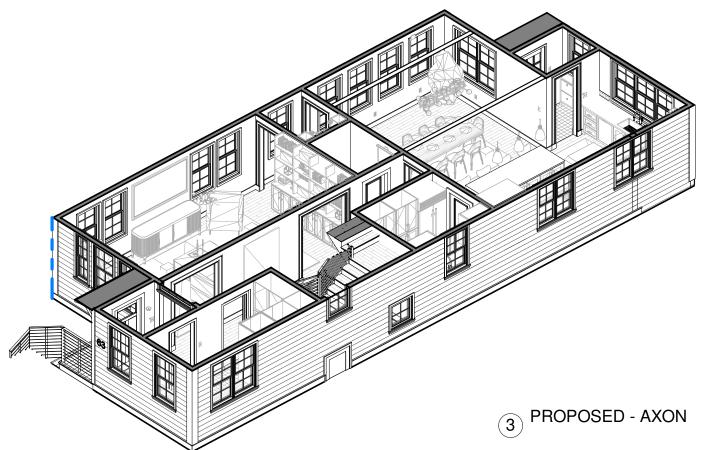



SAM KACHMAR ARCHITECTS

(p) 617-800-6223 www.SKA-MA.com 357 HURON AVE. CAMBRIDGE MA, 02138

REGISTRATIONS:

NOT FOR CONSTRUCTION

Clarendon Residen KIM MOTT JESSE

63 CLARENDON A CAMBRIDGE MA. 99

AVENUE \. 02140


Project Status	CONSTRUCTION DOCUMENTS
Project number	2301-6365
Date	07/18/2023
Drawn by	Author
Checked by	Checker

BZA-101 Scale As indicated

STRUCTURAL SCOPE.


TO BE DETERMINED BY

STRUCTURAL ENGINEER

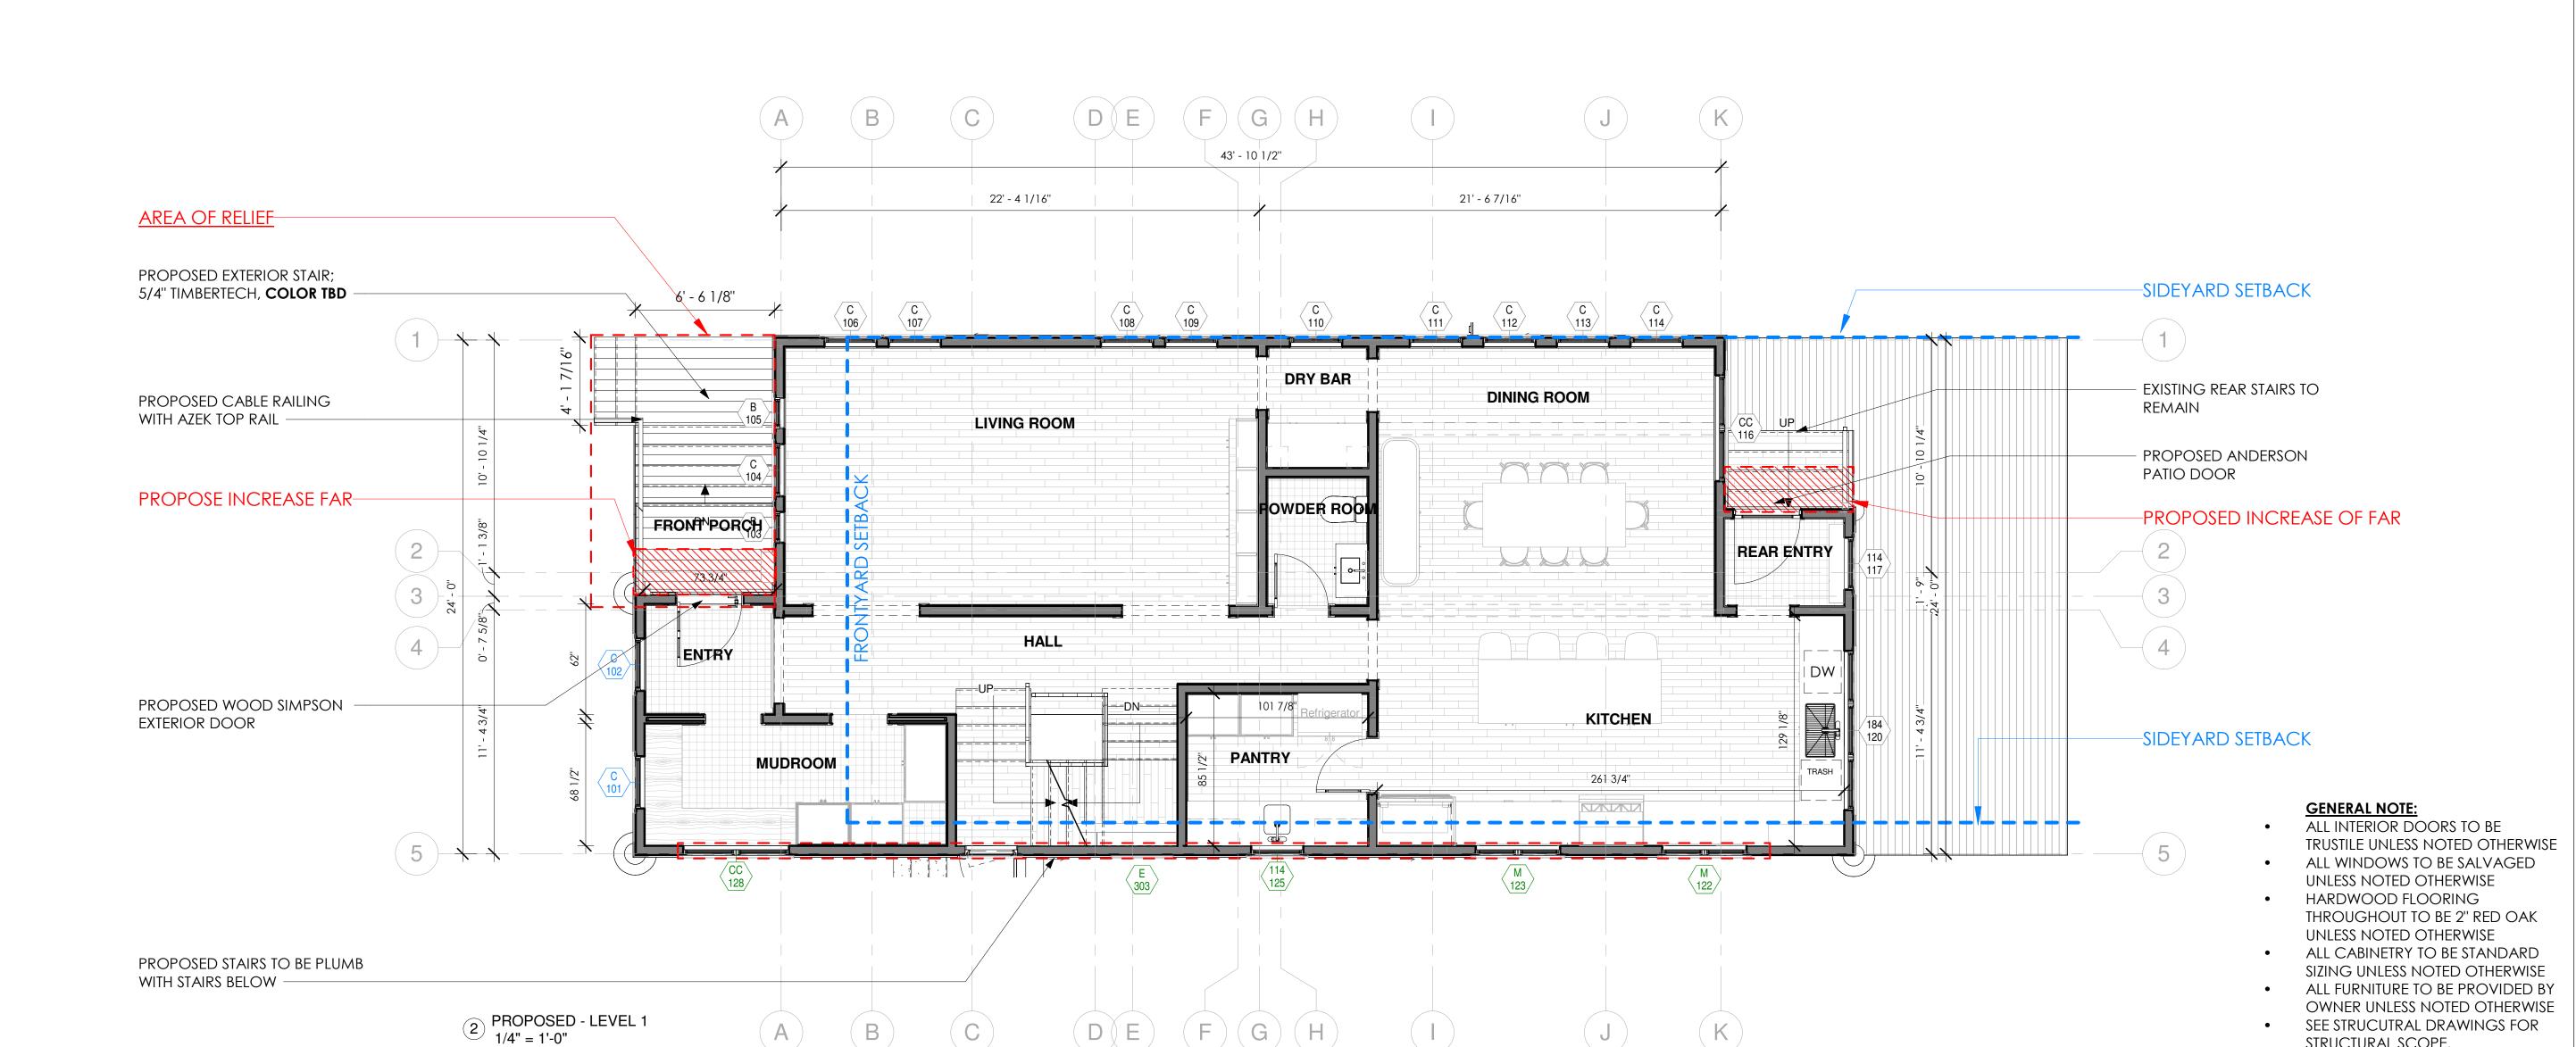


EXISITING WINDOWS IN

1 EXISTING - LEVEL 2 3/16" = 1'-0"

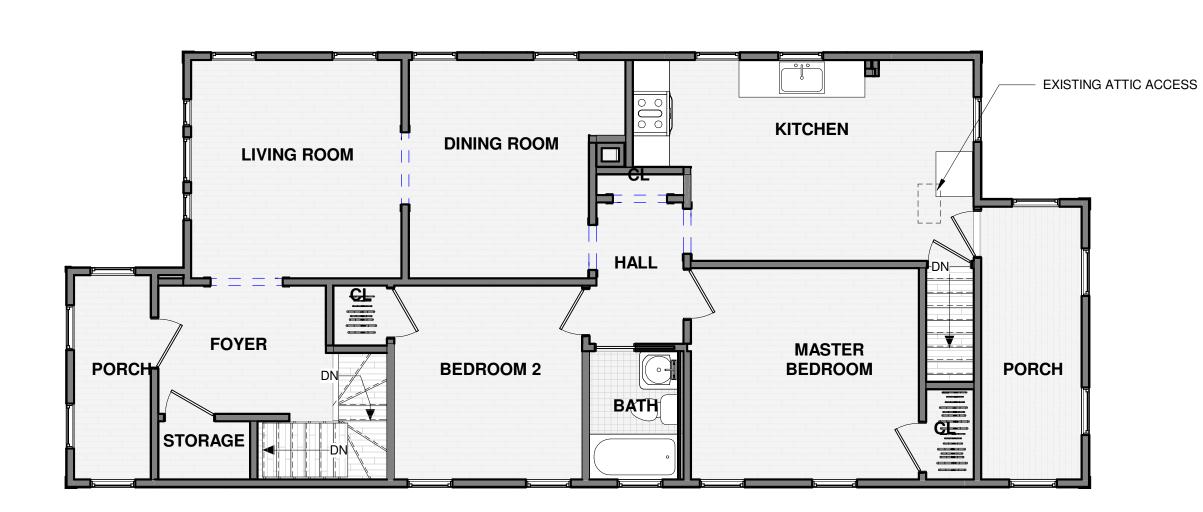



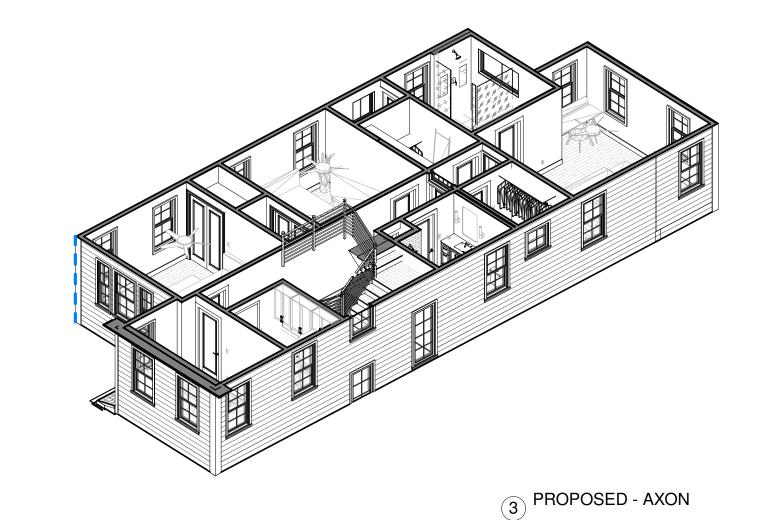

SAM KACHMAR ARCHITECTS

(p) 617-800-6223 www.SKA-MA.com 357 HURON AVE.

CAMBRIDGE MA, 02138

REGISTRATIONS:

NOT FOR CONSTRUCTION

99

KIM MOTT

63 CLARENDON A CAMBRIDGE MA. JESSE CONSTRUCTION DOCUMENTS Project Status 2301-6365 Project number Date 07/18/2023

Drawn by Author Checker Checked by

BEDROOM 1 TO BE PLACED PROPOSED SHINGLED ROOF OVER ENTRY TO MATCH EXISTING -15 SF BEDROOM 2 BEDROOM 1 140 SF 140 SF PROPOSE INCREASE FAR-CLOSET 1 CL. PROPOSED TRANSOM WINDOW OVER DOOR HALL MAIN BEDROOM MAIN BEDROOM EXISITING WINDOWS IN 160 SF 205 SF BEDROOM 1 TO BE PLACED OFFICE - PROPOSED 2X4 WET BATHROOM CLOSET 2 WALL LAUNDRY -SIDEYARD SETBACK 2 PROPOSED - LEVEL 2 1/4" = 1'-0" 5' - 4 1/2'' 43' - 10 1/2" F (G) H

 $D \otimes E$

22' - 4 1/16"

F (G) H

43' - 10 1/2"

21' - 6 7/16" -SIDEYARD SETBACK

PROPOSED INCREASE OF FAR

- ROOF TO BE REFRAMED AT EXISTING REAR PORCH

GENERAL NOTE:

ALL INTERIOR DOORS TO BE TRUSTILE UNLESS NOTED OTHERWISE ALL WINDOWS TO BE SALVAGED UNLESS NOTED OTHERWISE HARDWOOD FLOORING

THROUGHOUT TO BE 2" RED OAK UNLESS NOTED OTHERWISE ALL CABINETRY TO BE STANDARD SIZING UNLESS NOTED OTHERWISE


 ALL FURNITURE TO BE PROVIDED BY OWNER UNLESS NOTED OTHERWISE SEE STRUCUTRAL DRAWINGS FOR STRUCTURAL SCOPE.

TO BE DETERMINED BY STRUCTURAL ENGINEER


Scale

As indicated

AVENUE \. 02140

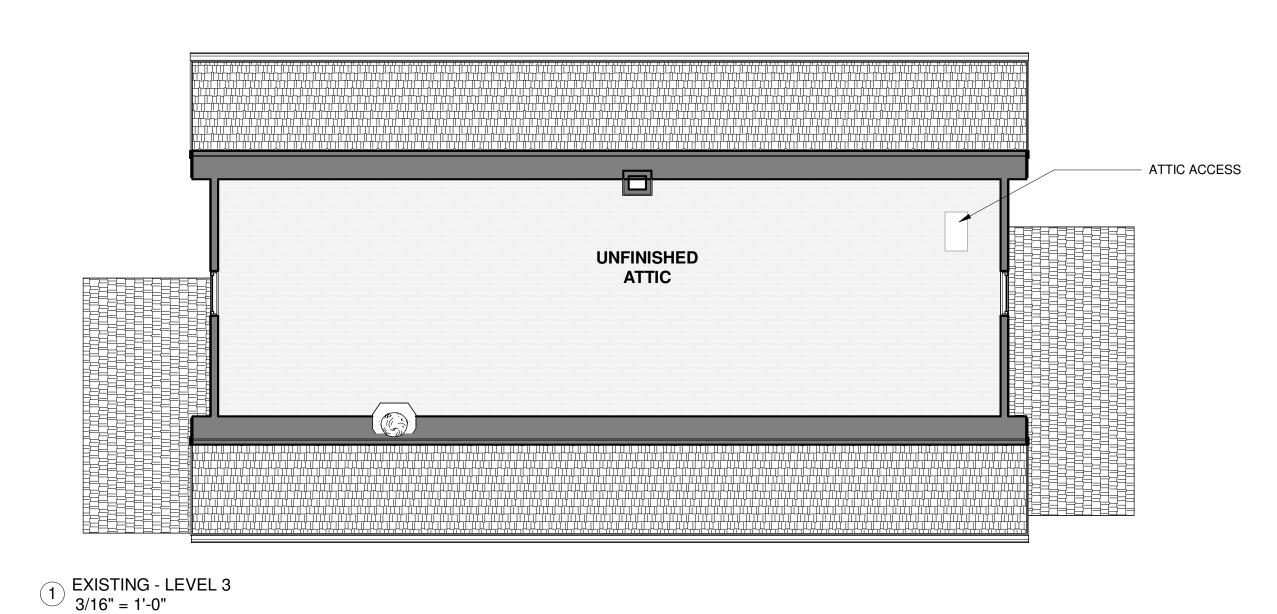



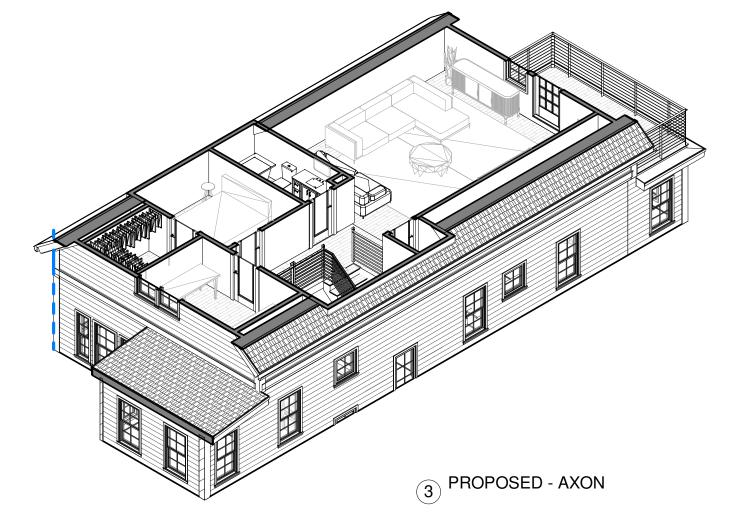



SAM KACHMAR ARCHITECTS

(p) 617-800-6223 www.SKA-MA.com 357 HURON AVE. CAMBRIDGE MA, 02138

REGISTRATIONS:

NOT FOR CONSTRUCTION

& KIM MOTT

JESSE


Scale

AVENUE A. 02140


63 CLARENDON A CAMBRIDGE MA. CONSTRUCTION DOCUMENTS Project Status 2301-6365 Project number Date 07/18/2023 Drawn by Author

Checker Checked by

As indicated

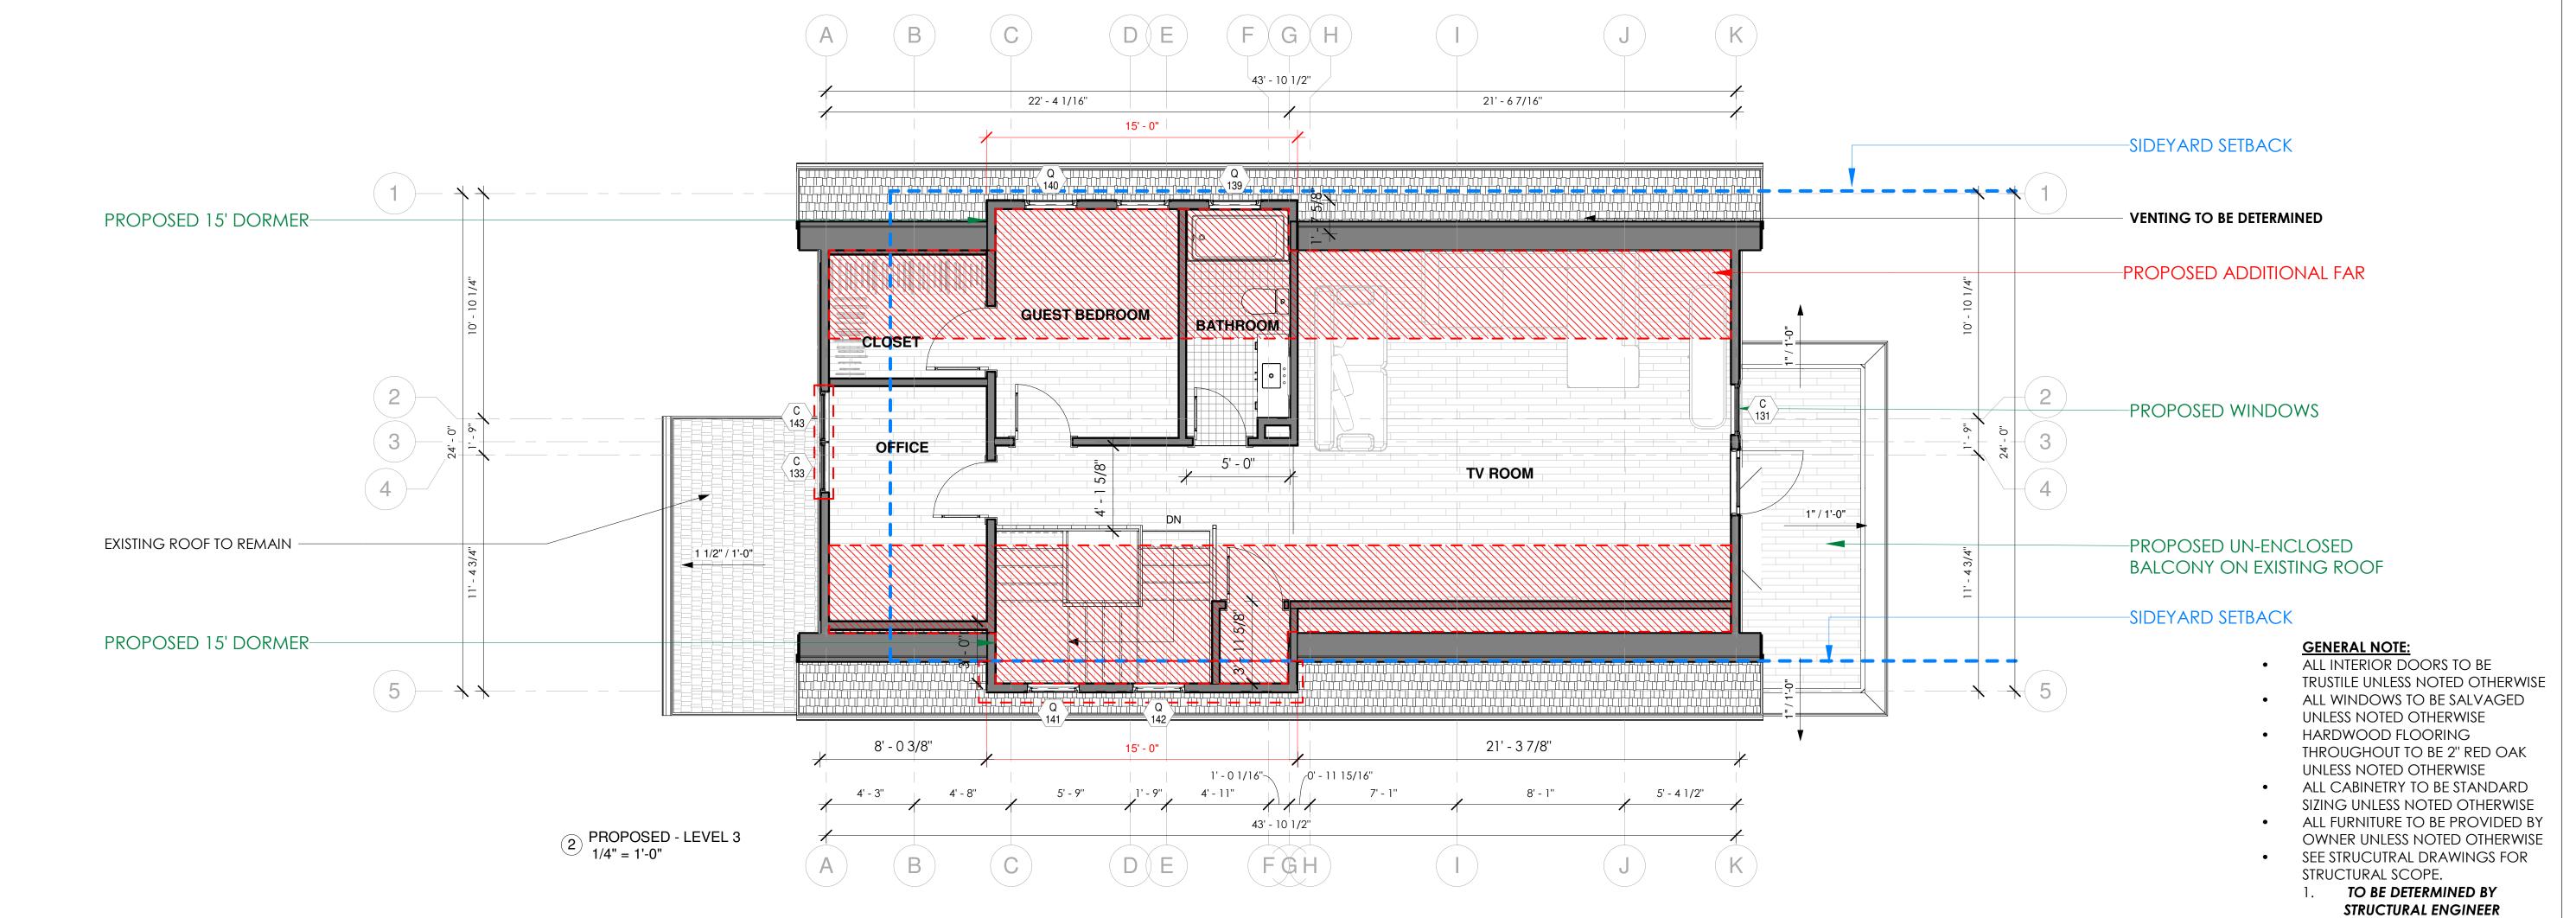


BZA-109**PLAN - ROOF**

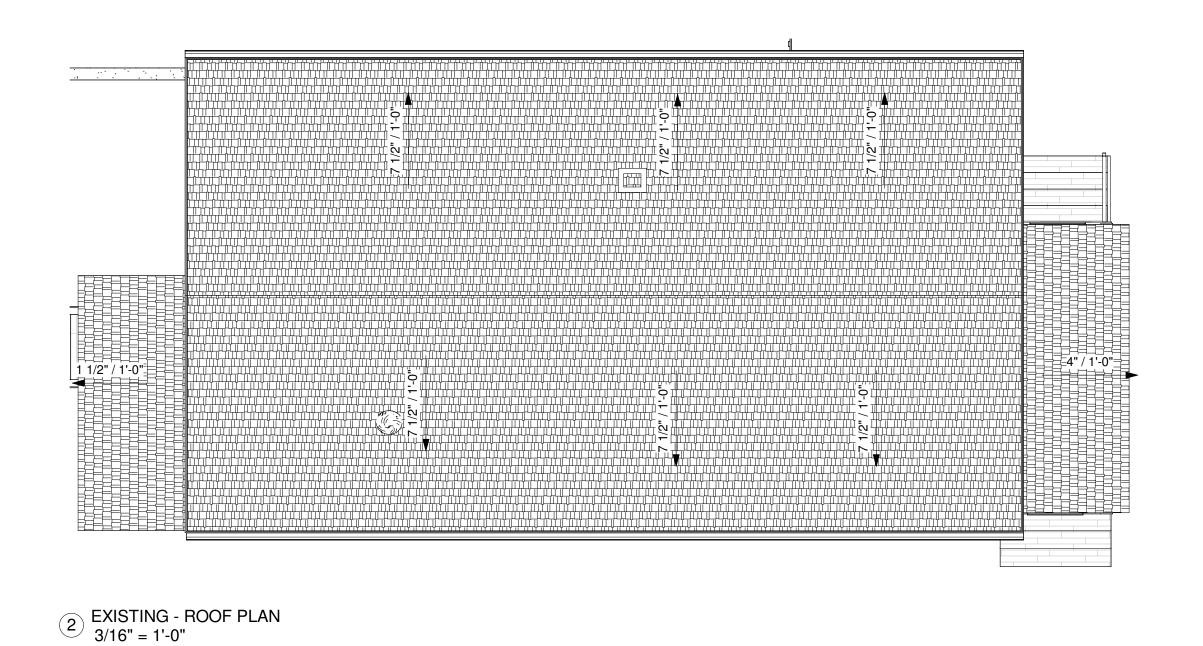

1) PROPOSED - ROOF PLAN 1/4" = 1'-0"



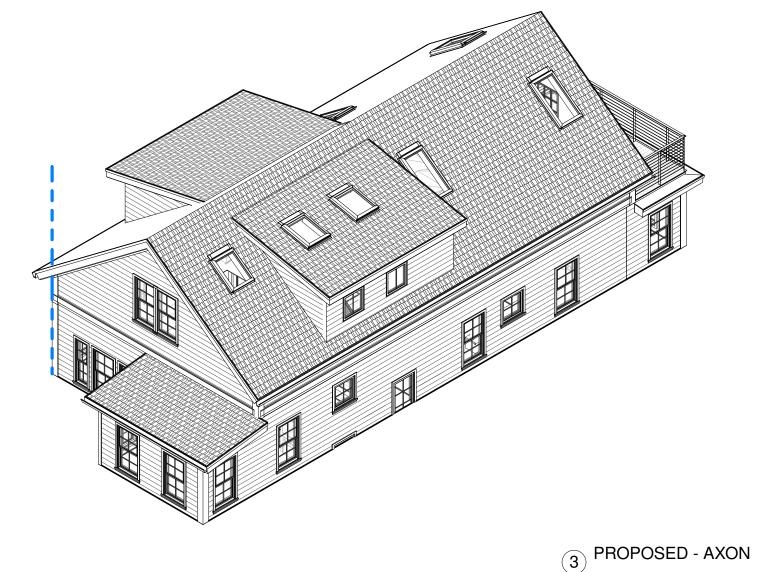



SAM KACHMAR ARCHITECTS

(p) 617-800-6223 www.SKA-MA.com 357 HURON AVE. CAMBRIDGE MA, 02138

REGISTRATIONS:


NOT FOR CONSTRUCTION

Clarendon Residen KIM MOTT 63-65 JESSE

63 CLARENDON AVENUE CAMBRIDGE MA. 02140 CONSTRUCTION DOCUMENTS Project Status 2301-6365 Project number Date 07/18/2023 Drawn by

Author Checker Checked by BZA-109

OWNER UNLESS NOTED OTHERWISE SEE STRUCUTRAL DRAWINGS FOR STRUCTURAL SCOPE. TO BE DETERMINED BY STRUCTURAL ENGINEER Scale As indicated

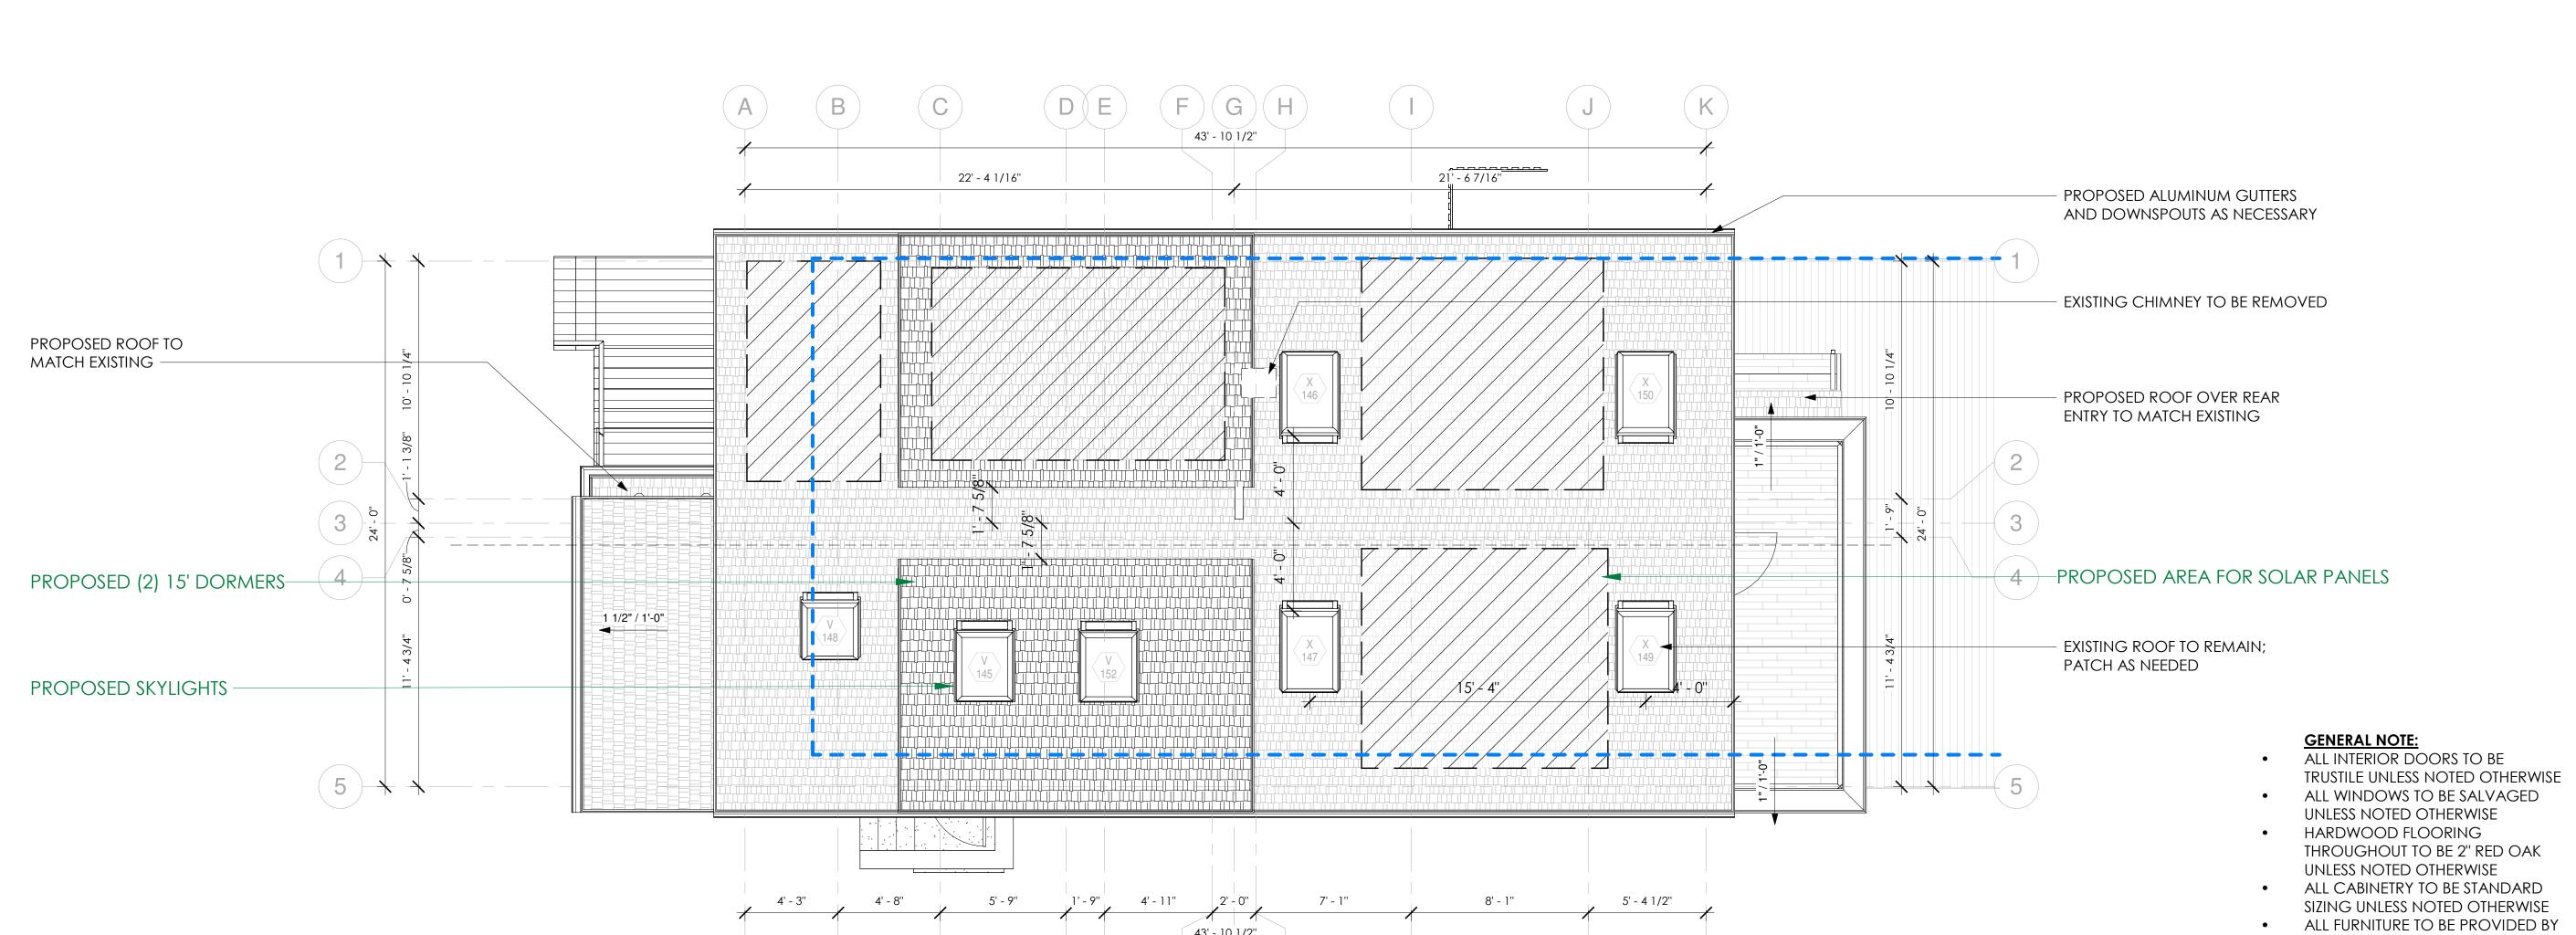

 $(\mathsf{F})(\mathsf{G})$







1 EXISTING - EAST ELEVATION 3/16" = 1'-0"



SAM KACHMAR ARCHITECTS

(p) 617-800-6223 www.SKA-MA.com 357 HURON AVE. CAMBRIDGE MA, 02138

REGISTRATIONS:

NOT FOR CONSTRUCTION

KIM MOTT

∞

JESSE

STRUCTURAL ENGINEER

63-65 Clarendon Residen

AVENUE A. 02140 63 CLARENDON A CAMBRIDGE MA.

	CONSTRUCTION
Project Status	DOCUMENTS
Project number	2301-6365
Date	07/18/2023
Drawn by	Author
Checked by	Checker


BZA-200 Scale

As indicated

1 EXISTING - NORTH ELEVATION 3/16" = 1'-0"

EXISTING

O

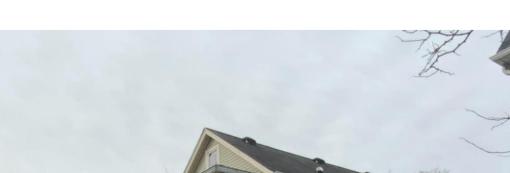



(p) 617-800-6223 www.SKA-MA.com 357 HURON AVE. CAMBRIDGE MA, 02138

REGISTRATIONS:

NOT FOR CONSTRUCTION

ELEV,

& KIM MOTT

JESSE

Scale

63-65 Clarendon Residence

CONSTRUCTION DOCUMENTS Project Status 2301-6365 Project number Date 07/18/2023 Author


63 CLARENDON AVENUE CAMBRIDGE MA. 02140

As indicated

Drawn by Checker Checked by BZA-201





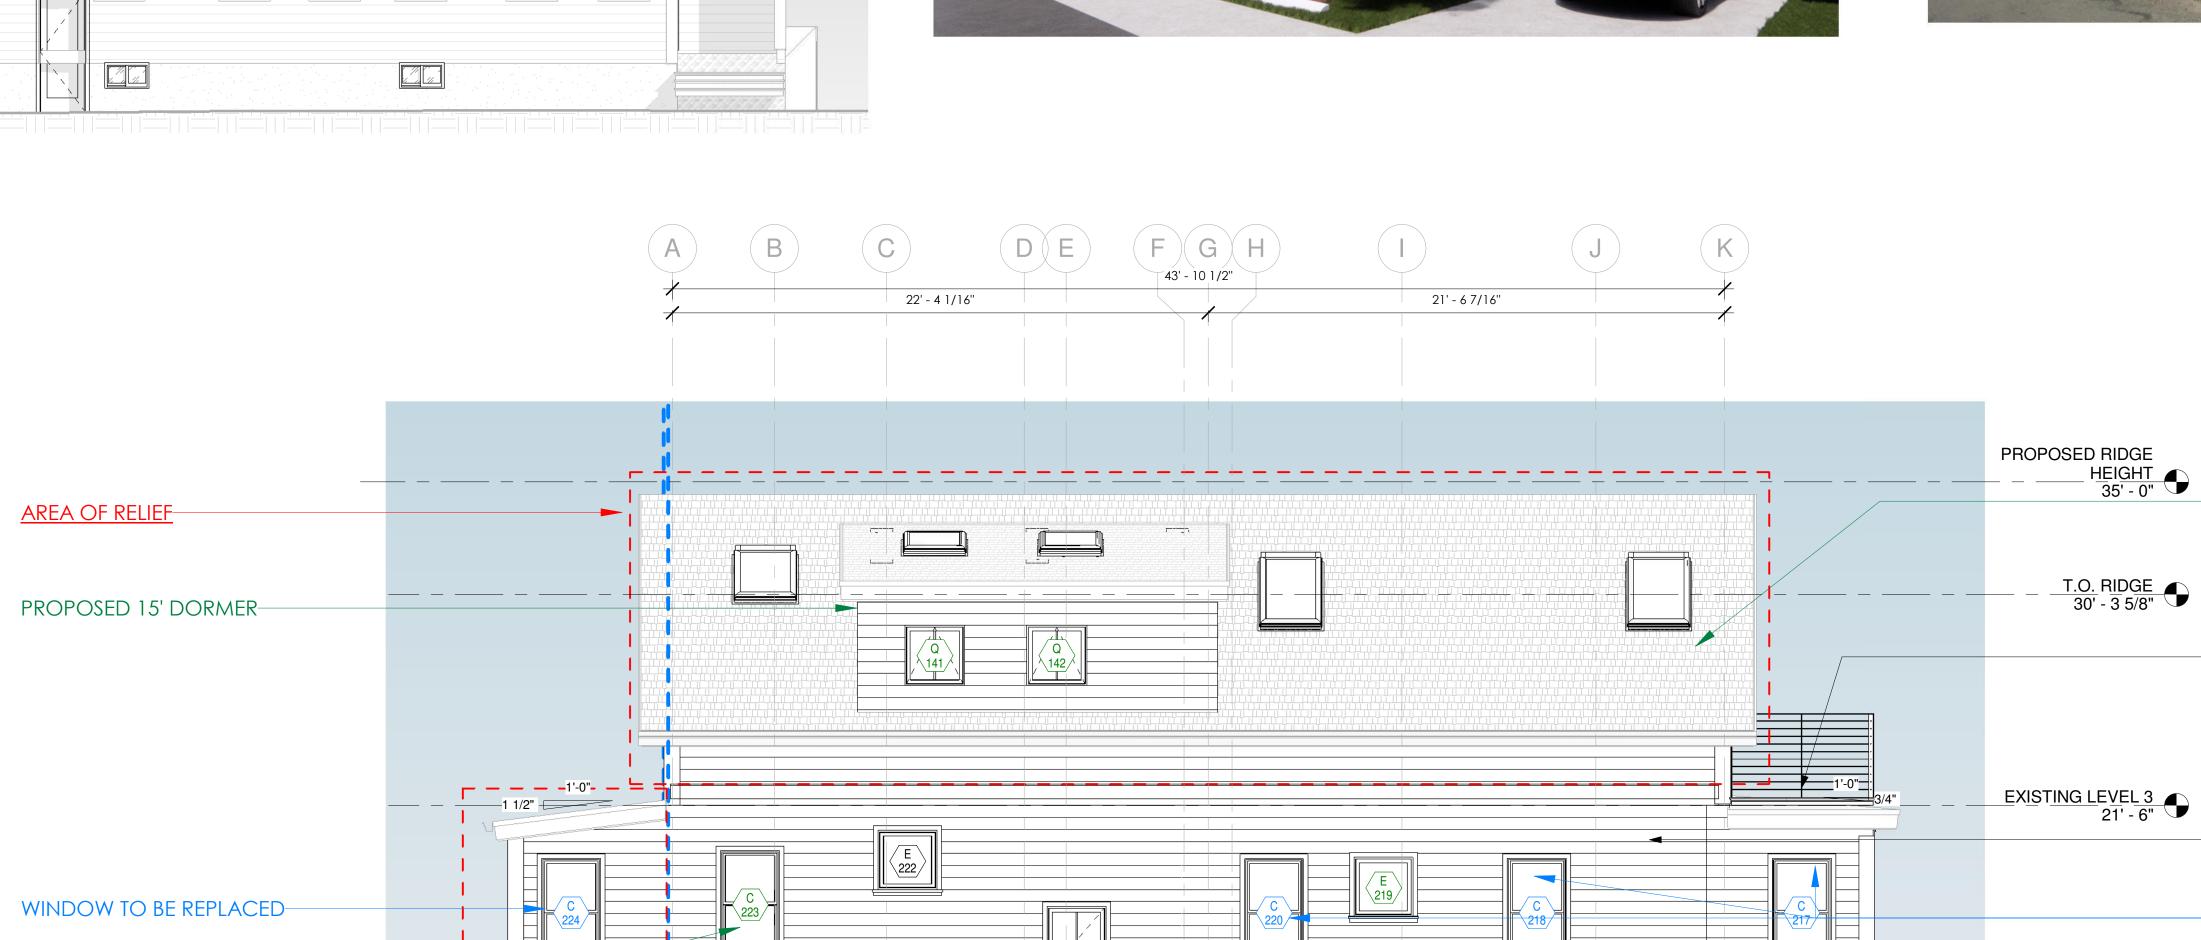

PROPOSED WINDOW-

PROPOSED HARVEY DOUBLE MULLED WINDOWS

EXISTING LATTICE TO REMAIN; PATCH AS NEEDED

WELL; EXCAVATE 24"

GENERAL NOTE:ALL WINDOWS TO BE SALVAGED

PROPOSED RAISED

- EXISTING RUBBER ROOF TO BE REFRAMED AT EXISTING PORCH

- EXISTING SIDING TO BE REPAINTED

-WINDOWS TO BE REPLACED

PROPOSED HARVEY DOUBLE

AND PATCHED AS NEEDED

PROPOSED WINDOW

MULLED WINDOWS

- PROPOSED INFILL WALL

ROOF

UNLESS NOTED OTHERWISE EXISTING CLAPBOARD SIDING TO

PATCH AS NECESSARY • EXISTING TRIM DETAILS TO REMAIN SEE A-204 FOR TRIM SHEET

• SEE STRUCTURAL DRAWINGS FOR STRUCTURAL SCOPE. TO BE DETERMINED BY

STRUCTURAL ENGINEER

EXISTING LEVEL 2 12' - 6"

EXISTING LEVEL 1 3' - 6" PROPOSED DOOR W/ DOOR

PROPOSED - NORTH ELEVATION 1/4" = 1'-0"








EXISTING

REGISTRATIONS:

1 EXISTING - WEST ELEVATION 3/16" = 1'-0"

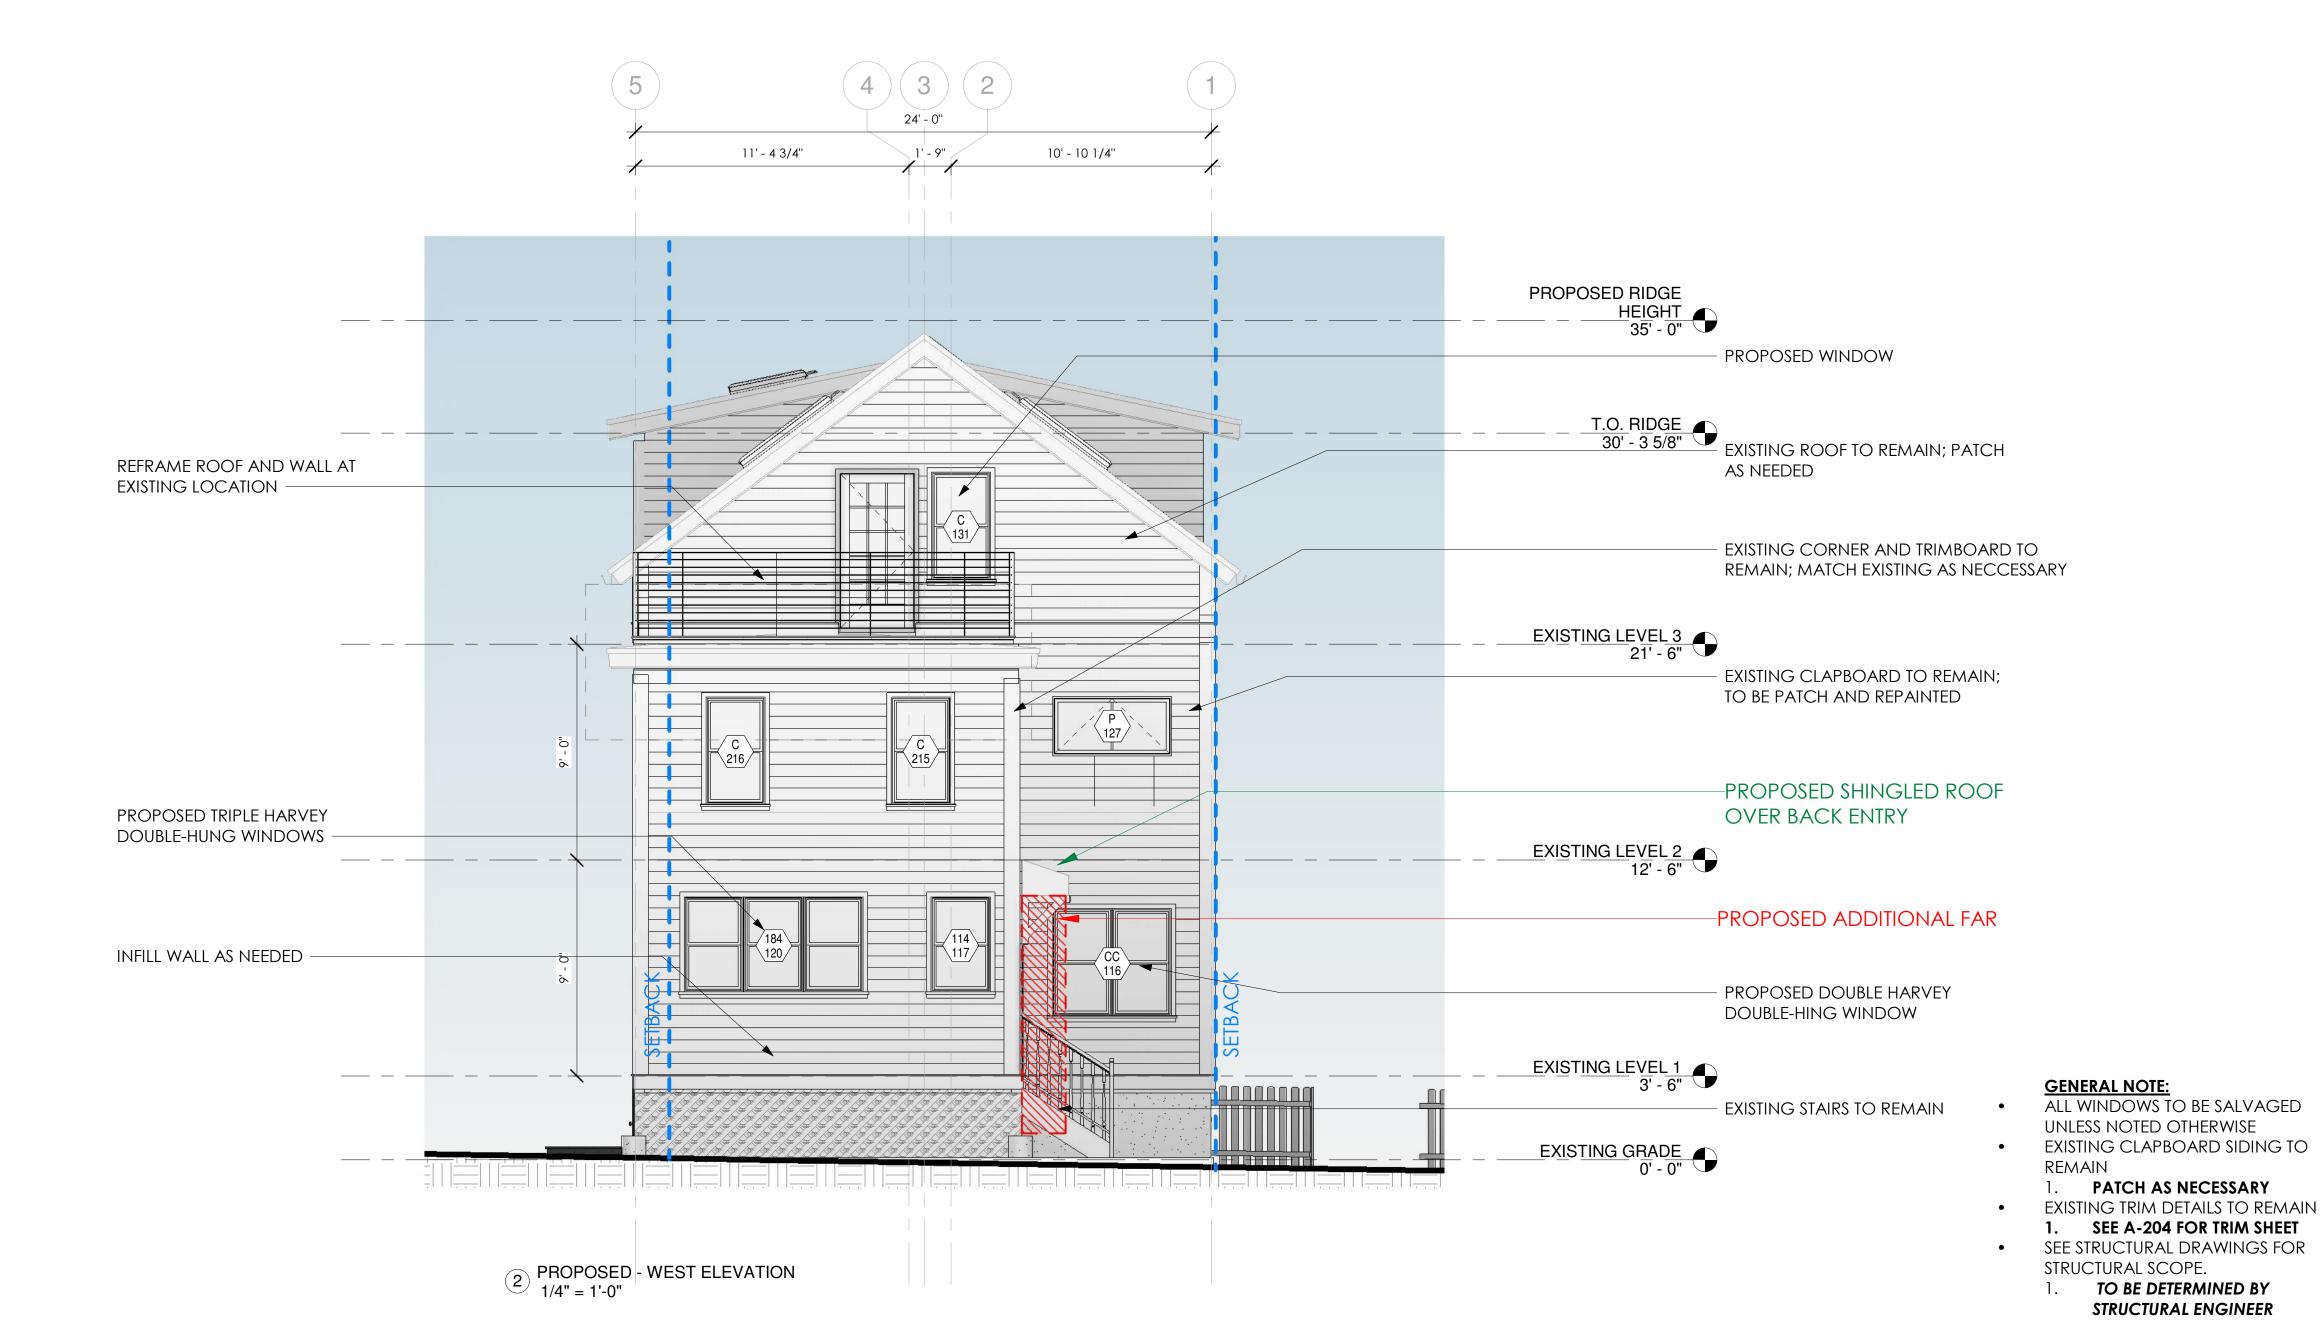

SAM KACHMAR ARCHITECTS

(p) 617-800-6223 www.SKA-MA.com 357 HURON AVE. CAMBRIDGE MA, 02138

NOT FOR

CONSTRUCTION

KIM MOTT

∞

JESSE

Scale


AVENUE \. 02140 63 CLARENDON A CAMBRIDGE MA. 99

	CONSTRUCTION
Project Status	DOCUMENTS
Project number	2301-6365
Date	07/18/2023
Drawn by	Author
Checked by	Checker

BZA-202

As indicated

EXISTING PROPOSED

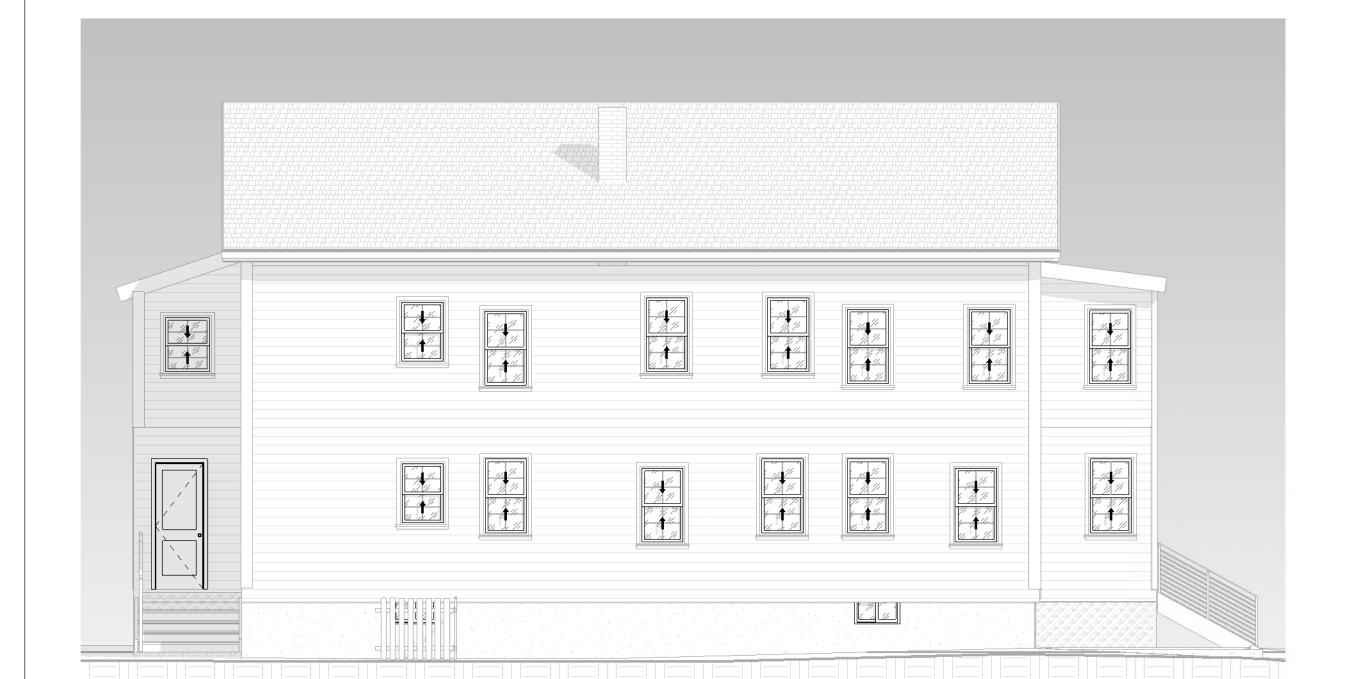

PROPOSED - SOUTH ELEVATION 1/4" = 1'-0"





SAM KACHMAR ARCHITECTS

(p) 617-800-6223 www.SKA-MA.com 357 HURON AVE. CAMBRIDGE MA, 02138

REGISTRATIONS:

NOT FOR

KIM MOTI

∞

JESSE

EXISTING TRIM DETAILS TO REMAIN

• SEE STRUCTURAL DRAWINGS FOR

STRUCTURAL SCOPE.

1. SEE A-204 FOR TRIM SHEET

TO BE DETERMINED BY

STRUCTURAL ENGINEER

99

Project Status Project number Date Drawn by

CONSTRUCTION

Residen

AVENUE \. 02140


63 CLARENDON A CAMBRIDGE MA.


CONSTRUCTION DOCUMENTS 2301-6365 07/18/2023 Author Checker Checked by

Scale As indicated

1 EXISTING - SOUTH ELEVATION 3/16" = 1'-0"

EXISTING

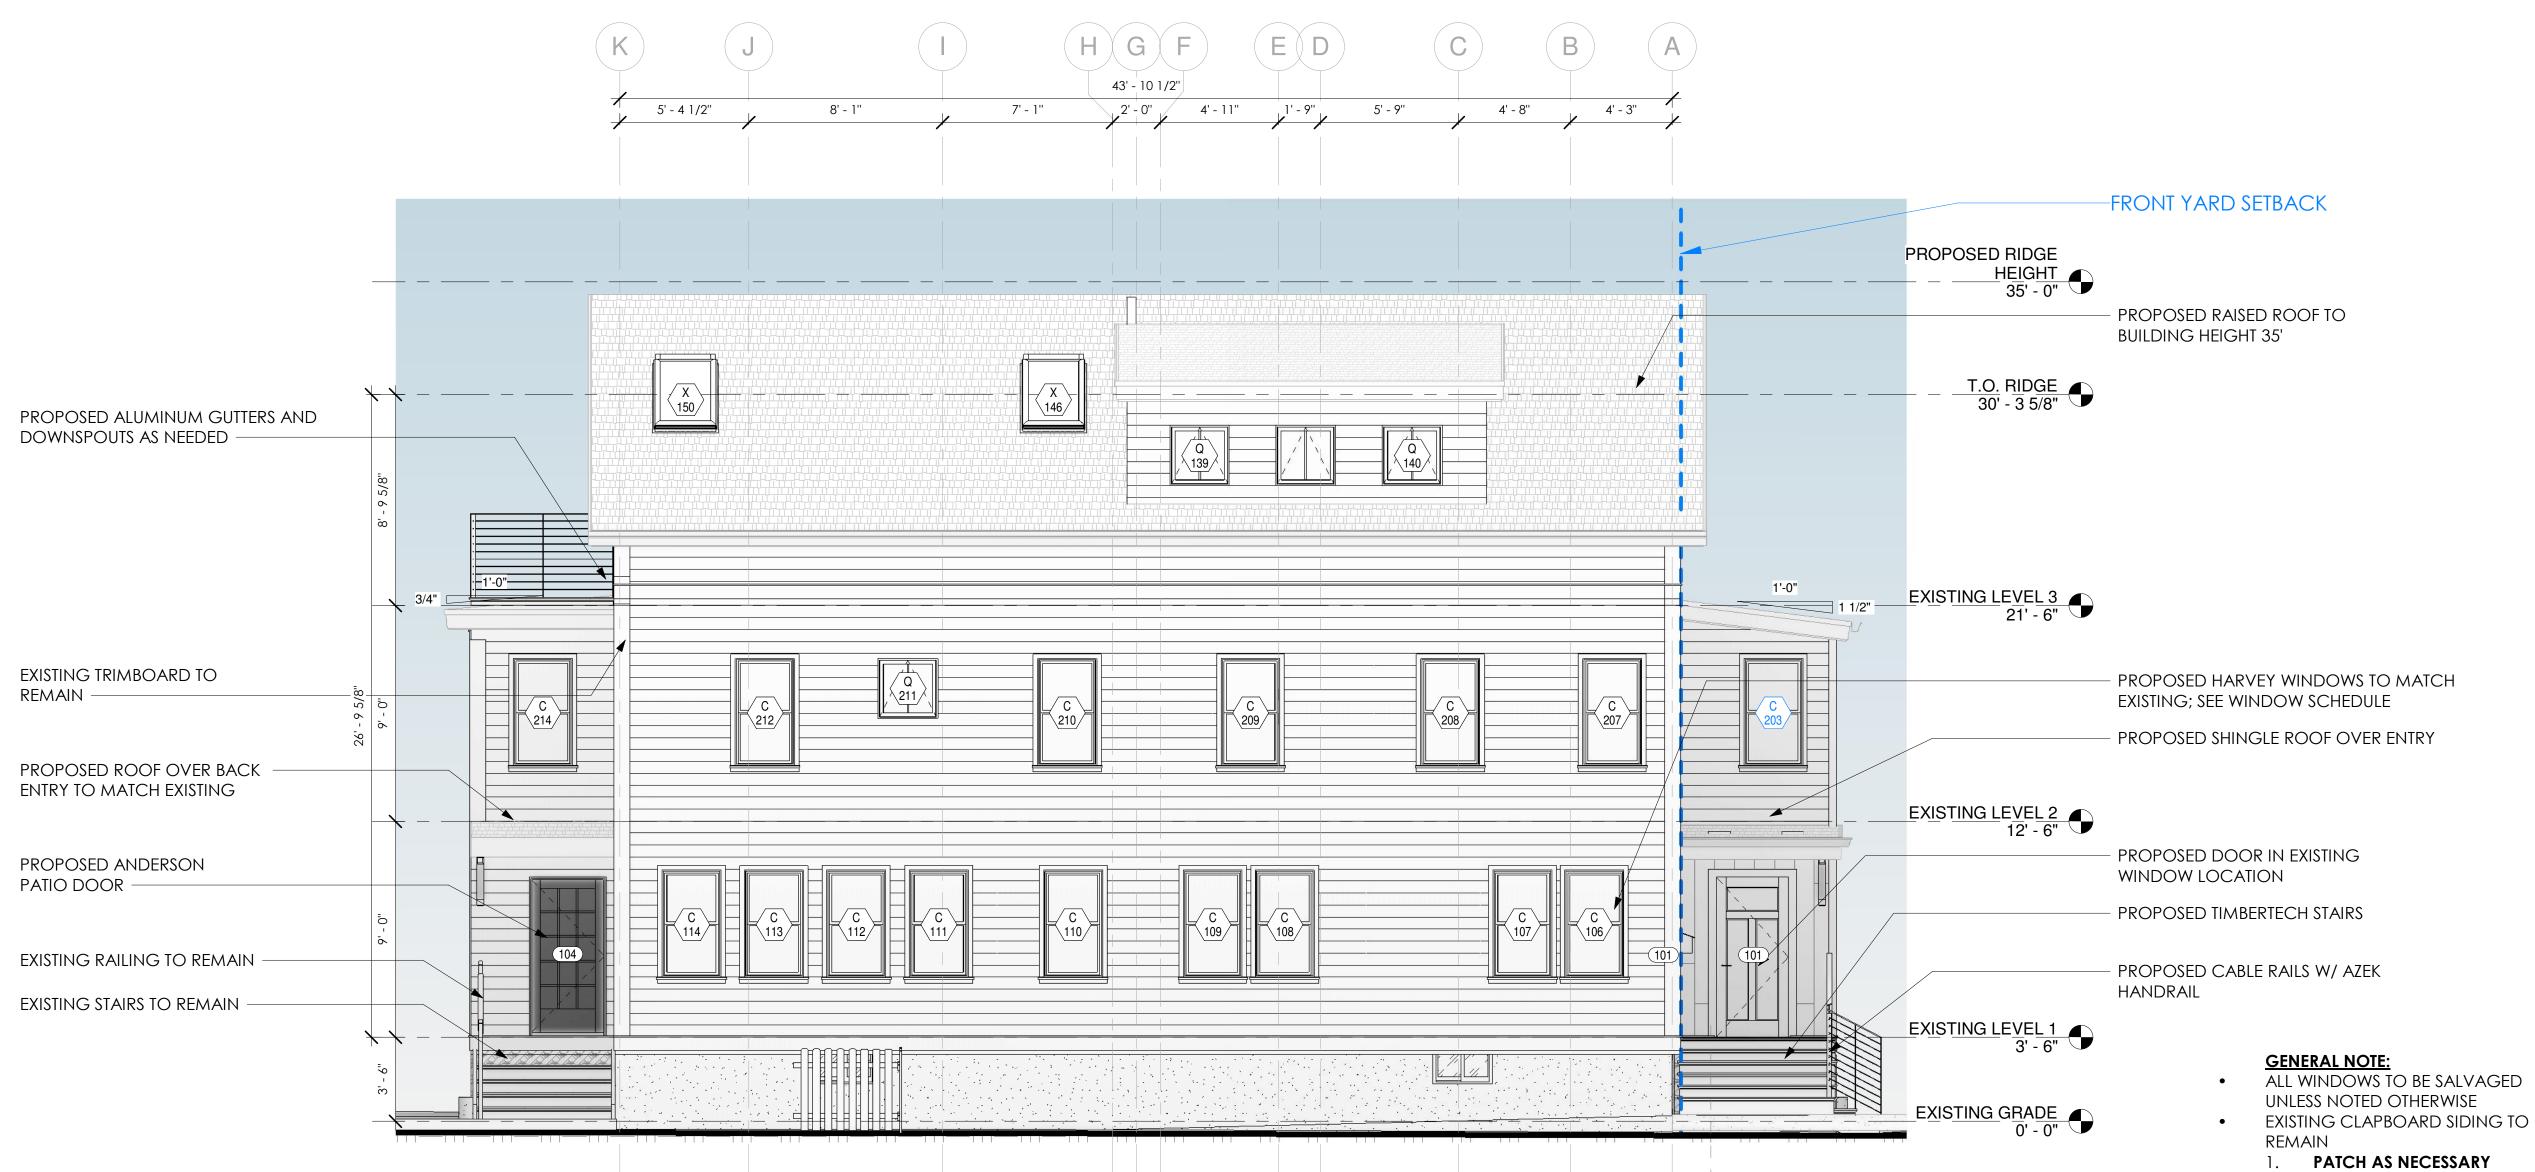

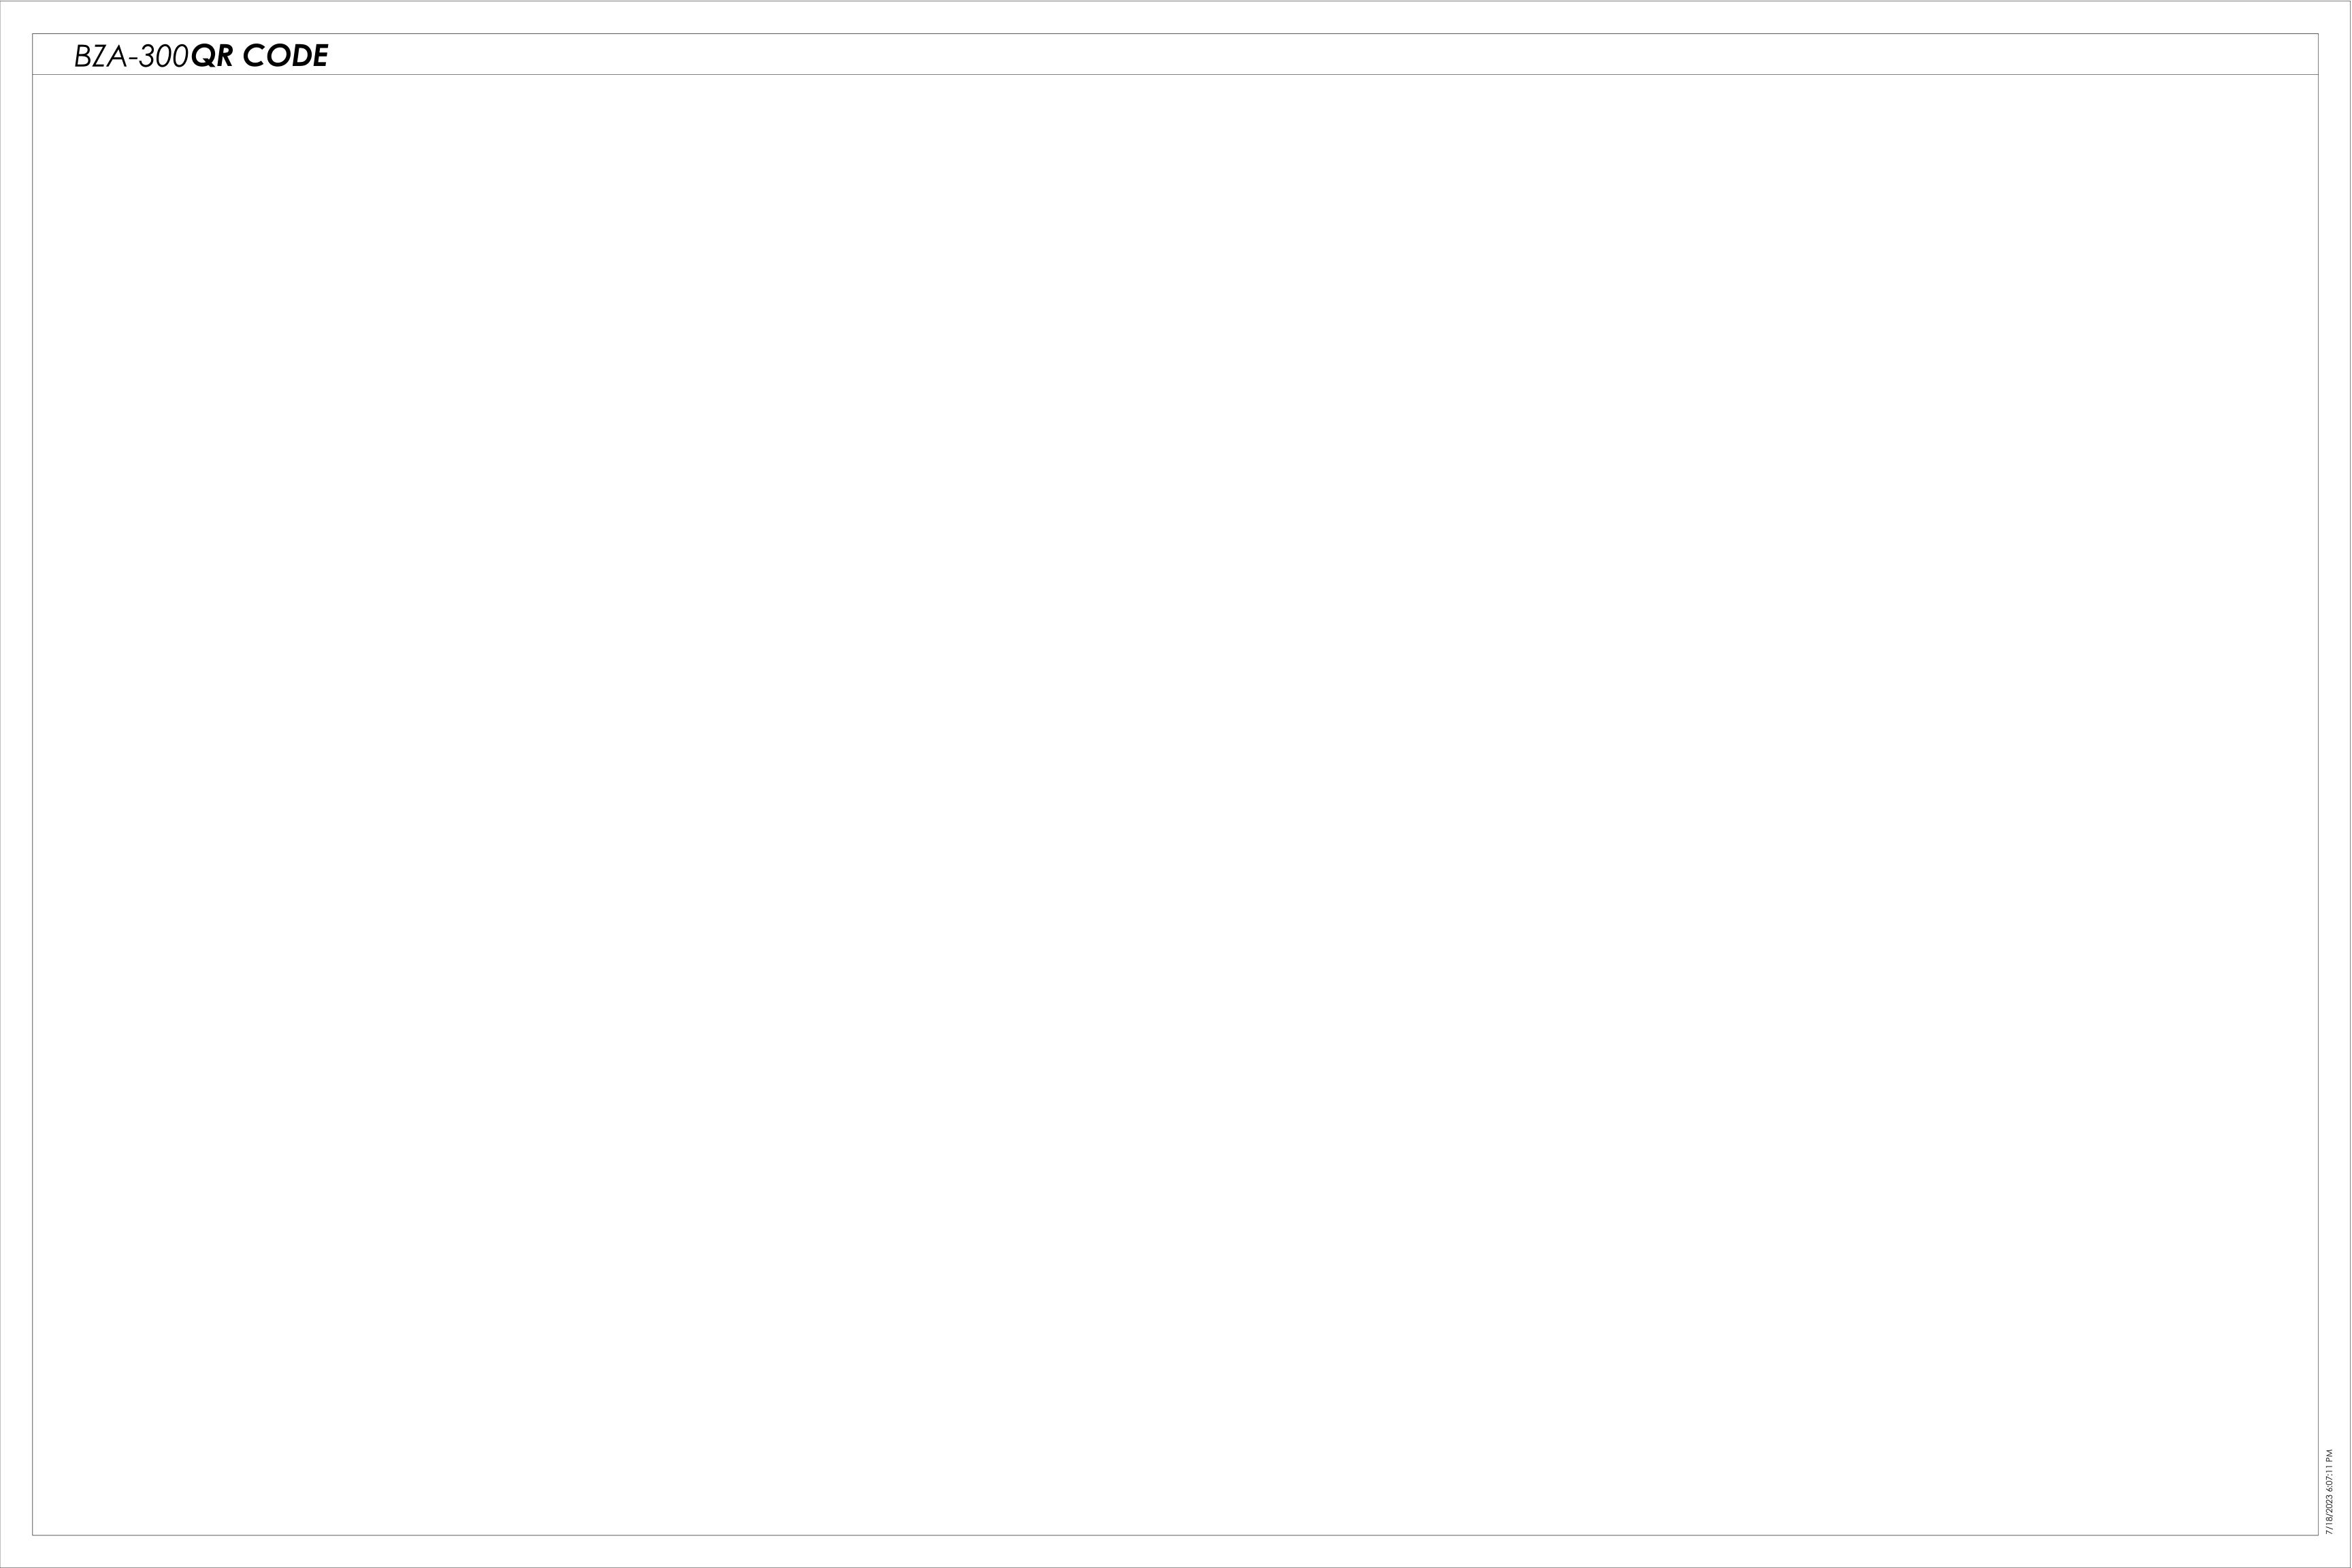

NOTES:

1. INFORMATION SHOWN ON THIS PLAN IS THE RESULT OF A FIELD SURVEY PERFORMED BY SPRUHAN ENGINEERING, P.C. AS OF 6/15/2023.

2. DEED REFERENCE: BOOK 76347, PAGE 81 PLAN REFERENCE 1: PLAN 410 OF 1972

PLAN REFERENCE 2: PLAN 215 OF 2020 PLAN REFERENCE 3: PL #57 1-17-2007

PLAN REFERENCE 4: 0184_1977 MIDDLESEX COUNTY SOUTH DISTRICT REGISTRY OF DEEDS

3. THIS PLAN IS NOT INTENDED TO BE RECORDED.


4. I CERTIFY THAT THE DWELLING SHOWN IS NOT LOCATED WITHIN A SPECIAL FLOOD HAZARD ZONE. IT IS LOCATED IN ZONE X, ON FLOOD HAZARD BOUNDARY MAP NUMBER 25017C0419E, IN COMMUNITY NUMBER: 250186, DATED 6/4/2010.

5. THIS PLAN DOES NOT SHOW ANY UNRECORDED OR UNWRITTEN EASEMENTS WHICH MAY EXIST. A REASONABLE AND DILIGENT ATTEMPT HAS BEEN MADE TO OBSERVE ANY APPARENT USES OF THE LAND; HOWEVER THIS NOT CONSTITUTE A GUARANTEE THAT NO SUCH EASEMENTS EXIST.

6. FIRST FLOOR ELEVATIONS ARE TAKEN AT THRESHOLD.

7. NO RESPONSIBILITY IS TAKEN FOR ZONING TABLE AS SPRUHAN ENGINEERING, P.C. ARE NOT ZONING EXPERTS. TABLE IS TAKEN FROM TABLE PROVIDED BY LOCAL ZONING ORDINANCE. CLIENT AND/OR ARCHITECT TO VERIFY THE ACCURACY OF ZONING ANALYSIS.

8. THE ELEVATIONS SHOWN ARE ON A CITY OF CAMBRIDGE DATUM.

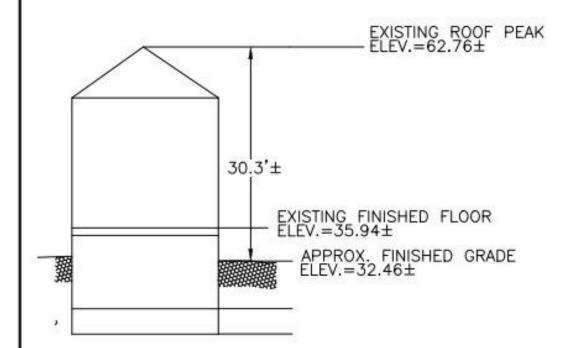


EXISTING PROFILE NOT TO SCALE

FLOOD ELEVATION (CAMBRIDGE FLOOD VIEWER 2022) CAMBRIDGE CITY BASE (FT-CBB) DATUM

Ground Elevation Min:	30.2 ft-CCB
Ground Elevation Max:	34.5 ft-CCB
2070 - 1% - SLR/SS	N/A
2070 - 1% - Precip	N/A
2070 - 10% - SLR/SS	N/A
2070 - 10% - Precip	N/A
2030 - 1% - Precip	N/A
2030 - 10% - Precip	N/A
Present Day - 1% - Precip	N/A
Present Day - 10% - Precip	N/A
FEMA 500-Year	N/A
FEMA 100-Year	N/A
1% - LTFE	N/A
10% - LTFE	N/A

Selected Map-Lot: 184-3 Selected Address: 63 Clarendon Ave.

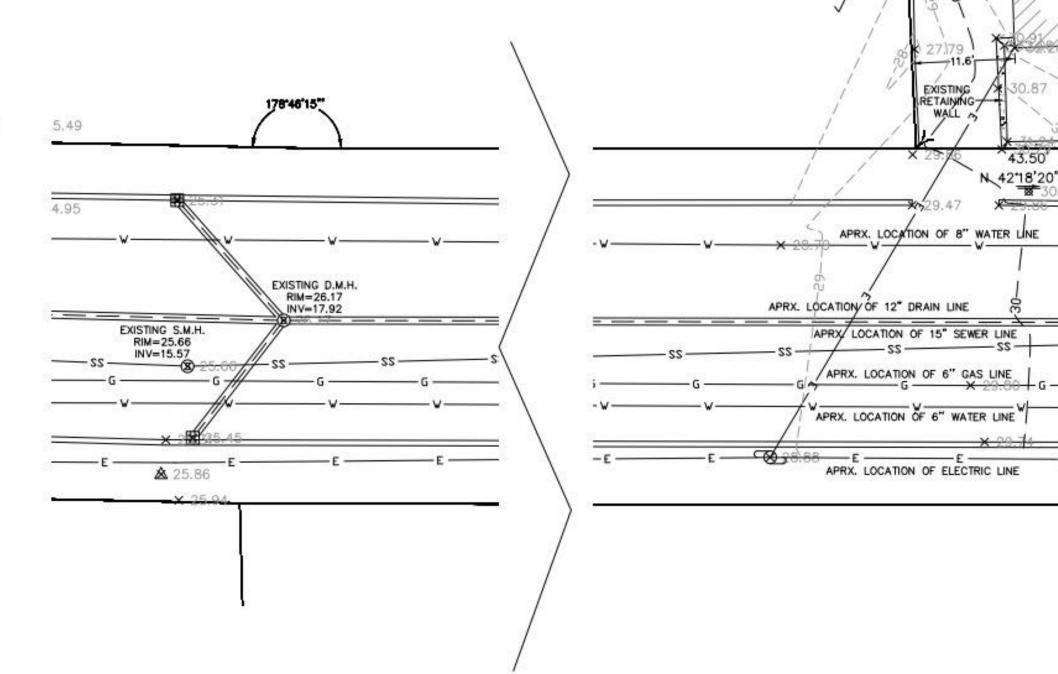

IRON PIN/PIPE ARCHDIOCESE CENTRAL STONE POST HIGH SCHOOL INC. BK. 46517, PG. 0099 TREE STUMP SHRUBS/FLOWERS EXISTING WOOD FENCE 0 BOLLARD SEWER MANHOLE **♦** × 32.56 **०** × 33.13 N 4218'20" E DRAIN MANHOLE CATCH BASIN WATER MANHOLE EXISTING EXISTING SHED ENTRY PARCEL ID: WATER VALVE 184-3 4,000 S.F. HYDRANT EXISTING — GARDEN WALL GARDEN GAS VALVE × × 1 37584 ELECTRIC MANHOLE EXISTING GARDEN ELECTRIC HANDHOLE 0 EXISTING WALKWAY UTILITY POLE # LIGHT POLE STEPS MANHOLE EXISTING PORCH SPOT GRADE WALKWAY TOP OF WALL BOTTOM OF WALL EXISTING BUILDING N/F LARCOMBE, JILL LOUISE BK. 35715, PG. 0342 RETAINING WALL STONE WALL WOOD -KANTOR, FREDERICK D. #63-65 EXISTING TREE LINE BK. 58833, PG. 0165 WOOD-FRAMED SEWER LINE RESIDENTIAL DRAIN LINE **DWELLING** FF=35.94 WATER LINE (TAKEN AT THRESHOLD) EXISTING DRIVEWAY GAS LINE UNDERGROUND ELECTRIC LINE -- OHW ----- OVERHEAD WIRES —145 CONTOUR LINE (MJR) 146 CONTOUR LINE (MNR) THEI 3' E AND 1-1' ACC R FOUND G TO THE PLAN. PLAN 215 OF 2020 PL #57 1-17-2007

APRX. LOCATION CLARENDON

OF SEWER LINE
CONNECTION

CONNECTION

65.50' (DEED) 68.50' (CALC)

(PUBLIC WAY - 40' WIDE)

N 4218'20" E 30.50

OF GAS LINE CONNECTION


APRX. LOCATION OF 8" WATER LINE

APRX, LOCATION OF 6" GAS LINE

APRX. LOCATION OF 6" WATER LINE

APRX. LOCATION OF ELECTRIC LINE

APRX. LOCATION OF 12" DRAIN LINE

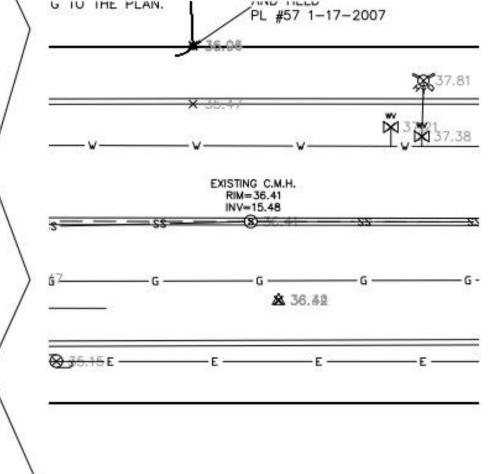

LEGEND

BOUND

□

	5 10	C SCALE	
	(IN	FEET) = 10 ft.	

PETER HOLAN & ASSOCIATES LLC SHALL NOT BE RESPONSIBLE FOR CONSTRUCTION MEANS, METHODS, TECHNIQUES, OR PROCEDURES UTLIZED BY THE CONTRACTOR, HOR FOR THE SAFETY OF PUBLIC OR CONTRACTOR'S EMPLOYEES, OR FOR THE FAILURE OF THE CONTRACTOR TO CAMPLY OUT THE MOTHING ACCOMPANCE WITH THE CONTRACT DOLORHEST.

THE EXTENT OF PETER MOLAN & ASSOCIATES LIABILITY FOR THIS PLAN IS LIMITED TO THE EXTENT OF ITS FEE LESS THRO PARTY COST. COPYRIGHT (C) 2023 by PETER NOLAN & ASSOCIATES LLC

All Rights Reserved C PART OF THIS DOCUMENT MAY BE REPRODUCED, STORED IN A RETREVAL SYSTEM, OR TRANSMITTED IN ANY FORM OR BY ANY MEANS, ELECTRONIC, ECHANICAL, PHOTOCOPYING, RECORDING OR OTHERWISE, WITHOUT THE PROFILE WEITEN PERMISSION OF PETER HOLAN & ASSOCIATES LLC ANY

SCALE 1"=10'					
DATE 7/17/2023	REV	DATE	REVISION	BY	
SHEET 1		63	-65 CLARENDON AVENUE	-	
PLAN NO. 1 OF 1			CAMBRIDGE MASSACHUSETTS		
CLIENT:		F	XISTING CONDITION PLAN		SHEET NO.
DRAWN BY s.g.s		-012	ETER NOLAN & ASSOCIATES LLO		1
CHKD BY PJN			ND SURVEYORS/CIVIL ENGINEERING CONSULTANT		
APPD BY PJN			80 JEWETT STREET, SUITE 1, NEWTON, MA. 02458 HONE: 857 891 747 AlL: pnolan@pnasurveyors.com		



1. INFORMATION SHOWN ON THIS PLAN IS THE RESULT OF A FIELD SURVEY PERFORMED BY SPRUHAN ENGINEERING, P.C. AS OF 6/15/2023.

2. DEED REFERENCE: BOOK 76347, PAGE 81 PLAN REFERENCE 1: PLAN 410 OF 1972

PLAN REFERENCE 1: PLAN 410 OF 1972 PLAN REFERENCE 2: PLAN 215 OF 2020 PLAN REFERENCE 3: PL #57 1-17-2007

PLAN REFERENCE 4: 0184_1977
MIDDLESEX COUNTY SOUTH DISTRICT REGISTRY OF DEEDS

3. THIS PLAN IS NOT INTENDED TO BE RECORDED.


4. I CERTIFY THAT THE DWELLING SHOWN IS NOT LOCATED WITHIN A SPECIAL FLOOD HAZARD ZONE. IT IS LOCATED IN ZONE X, ON FLOOD HAZARD BOUNDARY MAP NUMBER 25017C0419E, IN COMMUNITY NUMBER: 250186, DATED 6/4/2010.

5. THIS PLAN DOES NOT SHOW ANY UNRECORDED OR UNWRITTEN EASEMENTS WHICH MAY EXIST. A REASONABLE AND DILIGENT ATTEMPT HAS BEEN MADE TO OBSERVE ANY APPARENT USES OF THE LAND; HOWEVER THIS NOT CONSTITUTE A GUARANTEE THAT NO SUCH EASEMENTS EXIST.

6. FIRST FLOOR ELEVATIONS ARE TAKEN AT THRESHOLD.

7. NO RESPONSIBILITY IS TAKEN FOR ZONING TABLE AS SPRUHAN ENGINEERING, P.C. ARE NOT ZONING EXPERTS. TABLE IS TAKEN FROM TABLE PROVIDED BY LOCAL ZONING ORDINANCE. CLIENT AND/OR ARCHITECT TO VERIFY THE ACCURACY OF ZONING ANALYSIS.

8. THE ELEVATIONS SHOWN ARE ON A CITY OF CAMBRIDGE DATUM.

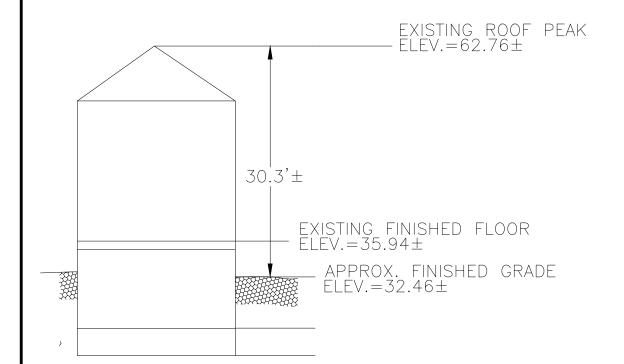


EXISTING PROFILE NOT TO SCALE


FLOOD ELEVATION (CAMBRIDGE FLOOD VIEWER 2022) CAMBRIDGE CITY BASE (FT-CBB) DATUM

Address: 63 Clarendon Ave

Ground Elevation Min:	30.2 ft-CCB
Ground Elevation Max:	34.5 ft-CCB
2070 - 1% - SLR/SS	N/A
2070 - 1% - Precip	N/A
2070 - 10% - SLR/SS	N/A
2070 - 10% - Precip	N/A
2030 - 1% - Precip	N/A
2030 - 10% - Precip	N/A
Present Day - 1% - Precip	N/A
Present Day - 10% - Precip	N/A
FEMA 500-Year	N/A
FEMA 100-Year	N/A
1% - LTFE	N/A
10% - LTFE	N/A

Selected Map-Lot: 184-3 Selected Address: 63 Clarendon Ave

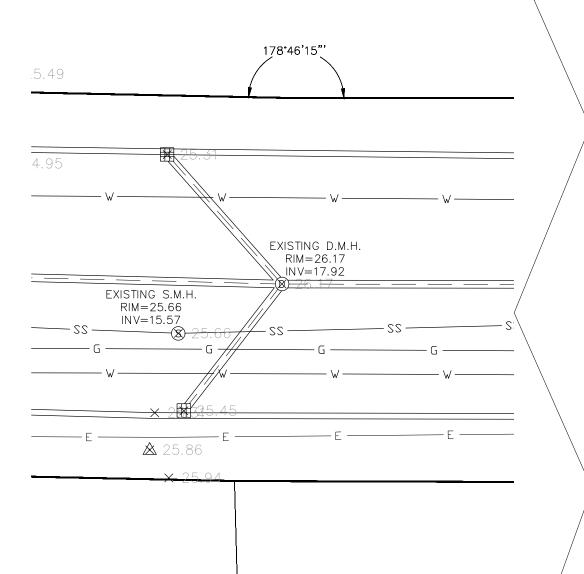

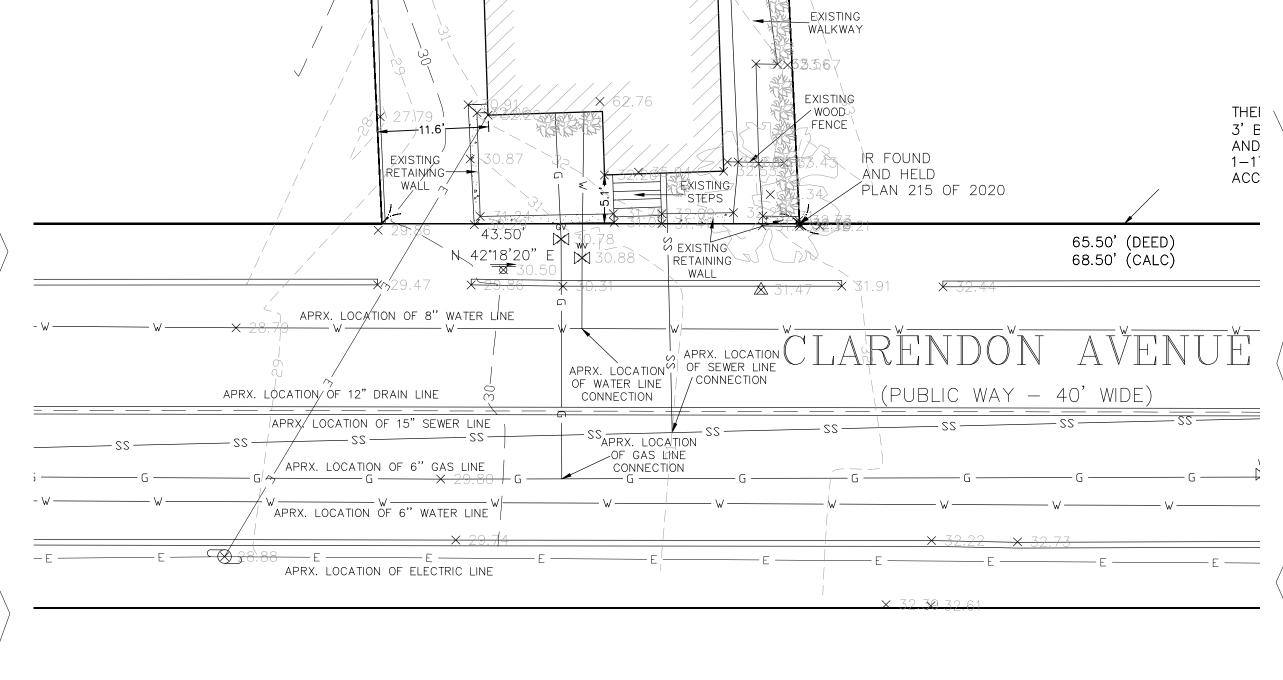

ARCHDIOCESE CENTRAL

HIGH SCHOOL INC.

BK. 46517, PG. 0099

EXISTING EXISTING SHED ENTRY

EXISTING GARDEN

EXISTING GARDEN

ÈXISTING

S(TEPS -

EXISTING DRIVEWAY

* *1.3/1584

LARCOMBE, JILL LOUISE BK. 35715, PG. 0342

EXISTING

WOOD ~

N 42°18'20" E

WOOD FENCE

PARCEL ID:

184-3

4,000 S.F.

EXISTING WALKWAY

ËXISTING

WOOD-FRAMED
RESIDENTIAL
DWELLING
FF=35.94
(TAKEN AT
THRESHOLD)

EXISTING STEPS \

EXISTING

PORCH

× 32.56 Q × 33.13

GARDEN

_EXISTING


WALKWAY

KANTOR, FREDERICK D.

BK. 58833, PG. 0165

WALL

	LEGEND
$\overline{}$	BOUND
0	IRON PIN/PIPE
\odot	STONE POST
	TREE
	TREE STUMP
(3)	SHRUBS/FLOWERS
-0-	SIGN
0	BOLLARD
S	SEWER MANHOLE
0	DRAIN MANHOLE
=	CATCH BASIN
W	WATER MANHOLE
wv 	WATER VALVE
\$	HYDRANT
GV M	GAS VALVE
E	ELECTRIC MANHOLE
EL	ELECTRIC HANDHOLE
	UTILITY POLE
\	LIGHT POLE
M	MANHOLE
X 148.00	SPOT GRADE
TW	TOP OF WALL
BW	BOTTOM OF WALL
	EXISTING BUILDING
	RETAINING WALL
	STONE WALL
<u> </u>	FENCE
	TREE LINE
S	SEWER LINE
D	DRAIN LINE
	WATER LINE
G	GAS LINE
E	UNDERGROUND ELECTRIC LINE
OHW	OVERHEAD WIRES
145	CONTOUR LINE (MJR)
146	CONTOUR LINE (MNR)

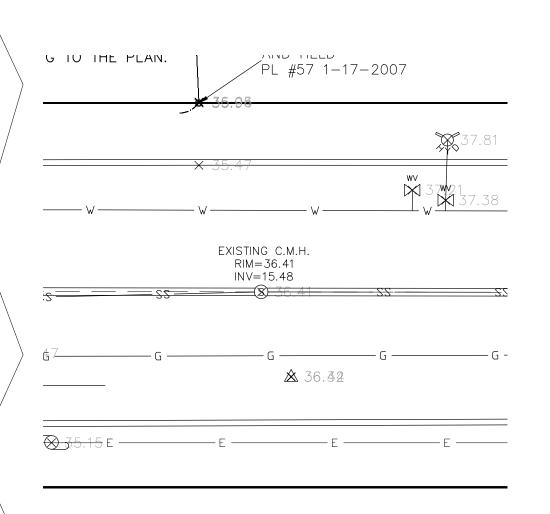

SCALE					
1"=10'					
DATE					
7/17/2023	REV	DATE	REVISION	BY	
SHEET 1 PLAN NO. 1 OF 1	-	63	3-65 CLARENDON AVENUE CAMBRIDGE MASSACHUSETTS		
CLIENT: DRAWN BY		Е	EXISTING CONDITION PLAN		SHEET NO.
S.G.S CHKD BY		·	ETER NOLAN & ASSOCIATES LLOND SURVEYORS/CIVIL ENGINEERING CONSULTANT		

80 JEWETT STREET, SUITE 1, NEWTON, MA. 02458
PHONE: 857 891 7478
EMAIL: pnolan@pnasurveyors.com

GRAPHIC SCALE

10 0 5 10 20 40

(IN FEET)
1 inch = 10 ft.

PETER NOLAN & ASSOCIATES LLC SHALL NOT BE RESPONSIBLE FOR CONSTRUCTION MEANS, METHODS, TECHNIQUES, OR PROCEDURES UTILIZED B CONTRACTOR, NOR FOR THE SAFETY OF PUBLIC OR CONTRACTOR'S EMPLOYEES; OR FOR THE FAILURE OF THE CONTRACTOR TO CARRY OUT THE WORKING ACCORDANCE WITH THE CONTRACT DOCUMENTS.

THE EXTENT OF PETER NOLAN & ASSOCIATES LIABILITY FOR THIS PLAN IS LIMITED TO THE EXTENT OF ITS FEE LESS THIRD PARTY COST

COPYRIGHT (C) 2023 by PETER NOLAN & ASSOCIATES LLC

All Rights Reserved

NO PART OF THIS DOCUMENT MAY BE REPRODUCED, STORED IN A RETRIEVAL SYSTEM, OR TRANSMITTED IN ANY FORM OR BY ANY MEANS, ELECTRONIC MECHANICAL, PHOTOCOPYING, RECORDING OR OTHERWISE, WITHOUT THE PRIOR WRITTEN PERMISSION OF PETER NOLAN & ASSOCIATES LLC ANY

COPYRIGHT (C) 2023 by PETER NOLAN & ASSOCIATES LIABILITY FOR THIS PLAN IS LIMITED TO THE EXTENT OF ITS FEE LESS THIRD PARTY COST

COPYRIGHT (C) 2023 by PETER NOLAN & ASSOCIATES LLC

All Rights Reserved





les Charcendon Are photos















63 Clarendon Ave

184-197 CAMBRIDGE HOUSING AUTHORITY 675 MASSACHUSETTS AVE CAMBRIDGE, MA 02139

184-15 SPLAINE, ESTHER A. & JOHN F. SPLAINE 62 CLARENDON AVE. CAMBRIDGE, MA 02140

185-57 VARIA, MAYANK H. 58 CHURCHILL AVE CAMBRIDGE, MA 02140

184-3 MOTT KIMBERLY C & JESSE A. MOTT 63-65 CLARENDON AVE CAMBRIDGE, MA 02140

184-13 /9-D-32 CACCIOLA REALTY, LLC 90 CLAREDON AVE SOMERVILLE, MA 02144

9-B-21 ADAM HEATH & FRANCES LITTELL 87 CLARENDON AVENUE SOMERVILLE, MA 02144 184-2 KANTOR, FREDERICK D. EVELYN Z. KANTOR-LUGO 69 CLARENDON AVE CAMBRIDGE, MA 02140

184-4 LARCOMBE, JILL LOUISE 61 CLARENDON AVE. CAMBRIDGE, MA 02140

185-57 ZHANG, SUIHUA 60 CHURCHILL AVE CAMBRIDGE, MA 02140

184-1 SHORE, DAVID & HALEY SHORE 91 CLARENDON AVE. UNIT 2 SOMERVILLE, MA 02144

9-B-22 ANDREW & LAUREN MILGROOM 91 CLARENDON AVENUE #1 SOMERVILLE, MA 02144


9-B-20 SUSI DELIO B & REBECCA M 85 CLARENDON AVENUE SOMERVILLE, MA 02144 MICHAEL WIGGINS, ESQ.
ONE LIBERTY SQUARE – SUITE 1210
BOSTON, MA 02109

185-58 / 9-B-23 ARCHDIOCESE CENTRAL HIGH SCHOOL INC. 2121 COMMONWEALTH AVENUE BRIGHTON, MA 02135

185-57 TANWAR, PRITHVIRAJ & KERRY L. TANWAR 56 CHURCHILL AVE 56 CAMBRIDGE, MA 02140

184-14 PHYTOVISIO LLC 4 MORTON ST CONCORD, NH 03301

9-B-22 DAVID & HALEY SHORE 91 CLARENDON AVENUE #2 SOMERVILLE, MA 02144

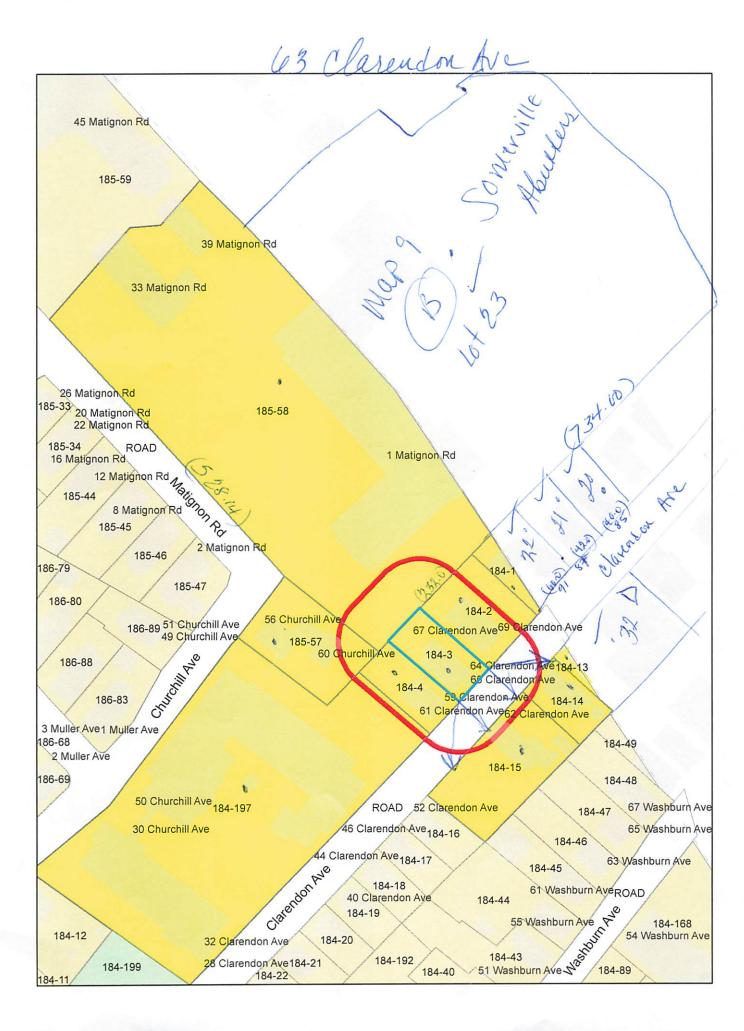



ENDICOTT AVE

ENDICOTT AVE Location

Mblu 9/ B/ 23/ /

Acct# 99734060

ARCHDIOCESAN CENTRAL Owner

HIGH SCHOOLS INC

Assessment \$16,340,000

PID 14653

Building Count 1

Current Value

Assessment						
Valuation Year Improvements Land Total						
2023	\$4,032,800	\$12,307,200	\$16,340,000			

Owner of Record

Owner

ARCHDIOCESAN CENTRAL HIGH SCHOOLS INC

Sale Price \$99

Co-Owner

Certificate

Book & Page

Address

2121 COMMONWEALTH AVE

BRIGHTON, MA 02135

Sale Date 11/21/2005

46517/099

Instrument 1F

Ownership History

Ownership History						
Owner	Sale Price	Certificate	Book & Page	Instrument	Sale Date	
ARCHDIOCESAN CENTRAL HIGH SCHOOLS INC	\$99		46517/ 099	1F	11/21/2005	
ROMAN CATHOLIC ARCHBISHOP	\$0					

Building Information

Building 1: Section 1

Year Built:

1948

Living Area:

59,506

Replacement Cost:

\$12,987,496

Building Percent Good:

30

Replacement Cost

Less Depreciation:

\$3,896,200

Building Attributes					
Field	Description				

91 CLARENDON AVE #1

Location 91 CLARENDON AVE #1

Mblu 9/ B/ 22/ 1/

Acct# 20221740

Owner **MILGROOM LAUREN &**

ANDREW

Assessment \$1,177,900

PID 114369

Building Count 1

Assessing District

Current Value

Assessment					
Valuation Year Improvements Land Total					
2023	\$1,177,900	\$0	\$1,177,900		

Owner of Record

Owner

MILGROOM LAUREN & ANDREW

Sale Price

\$1,200,000

Co-Owner

91 CLARENDON AVE 1

Certificate

Address

Book & Page 74376/254

SOMERVILLE, MA 02144

Sale Date

03/30/2020

Instrument

00

Ownership History

Ownership History							
Owner Sale Price Certificate Book & Page Instrument Sale Dat							
MILGROOM LAUREN & ANDREW	\$1,200,000		74376/ 254	00	03/30/2020		
91 CLARENDON DEVELOPMENT LLC	\$1,125,000		70494/ 322	10	01/10/2018		

Building Information

Building 1: Section 1

Year Built:

1920

Living Area:

1,837

Replacement Cost:

\$1,218,430

Building Percent Good:

96

Replacement Cost

Less Depreciation:

\$1,169,700

Building Attributes

91 CLARENDON AVE #2

Location 91 CLARENDON AVE #2

Mblu 9/ B/ 22/ 2/

Acct# 20221750

Owner SHORE DAVID & HALEY

Assessment \$851,600

PID 114370

Building Count 1

Assessing District

Current Value

Assessment				
Valuation Year Improvements Land Tota		Total		
2023	\$851,600	\$0	\$851,600	

Owner of Record

Owner

SHORE DAVID & HALEY

Sale Price Certificate \$1,325,000

Co-Owner Address

91 CLARENDON AVE 2

Book & Page 74381/ 177

SOMERVILLE, MA 02144

Sale Date

03/31/2020

Instrument

1T

Ownership History

Ownership History					
Owner	Sale Price	Certificate	Book & Page	Instrument	Sale Date
SHORE DAVID & HALEY	\$1,325,000		74381/ 177	1T	03/31/2020
91 CLARENDON DEVELOPMENT LLC	\$1,125,000		70494/ 322	10	01/10/2018

Building Information

Building 1: Section 1

Year Built:

1920

Living Area:

2,064

Replacement Cost:

\$1,299,303

Building Percent Good:

65

Replacement Cost

Less Depreciation:

\$844,500

Building Attributes				
Field	Field Description			

87 CLARENDON AVE

Location 87 CLARENDON AVE

Mblu 9/ B/ 21/ /

Acct# 16549020

Owner HEATH ADAM

Assessment \$1,113,300

PID 2877

Building Count 1

Current Value

Assessment				
Valuation Year	Improvements	Land	Total	
2023	\$486,800	\$626,500	\$1,113,300	

Owner of Record

Owner HEATH ADAM

Sale Price \$375,000

Co-Owner LITTELL FRANCES

Certificate

Address 87 CLARENDON AVE

Book & Page 33109/509

SOMERVILLE, MA 02144

Sale Date 06/22/2001

Instrument 1A

Ownership History

Ownership History					
Owner	Sale Price	Certificate	Book & Page	Instrument	Sale Date
HEATH ADAM	\$375,000		33109/ 509	1A	06/22/2001
LITTELL WALTER D	\$249,000		21451/ 534	00	10/01/1991
JOHN SNELL	\$0				

Building Information

Building 1: Section 1

Year Built:

1927

Living Area:

3,058

Replacement Cost:

\$624,049

Building Percent Good:

78

Replacement Cost

Less Depreciation:

\$486,800

Building Attributes		
Field	Description	

85 CLARENDON AVE

Location 85 CLARENDON AVE

Mblu 9/ B/ 20/ /

Acct# 02057190

Owner SUSI DELIO B & REBECCA M

Assessment \$1,167,700

PID 2876

Building Count 1

Current Value

Assessment				
Valuation Year	Improvements	Land	Total	
2023	\$540,800	\$626,900	\$1,167,700	

Owner of Record

Owner SUSI DELIO B & REBECCA M

Sale Price

Co-Owner

Certificate

Address 85 CLARENDON AVE

Book & Page 61056/ 11

SOMERVILLE, MA 02144

Sale Date 01/28/2013

\$1

Instrument

1F

Ownership History

Ownership History					
Owner	Sale Price	Certificate	Book & Page	Instrument	Sale Date
SUSI DELIO B & REBECCA M	\$1		61056/ 11	1F	01/28/2013
SUSI DELIO B	\$370,000		33842/ 170	00	10/17/2001
BOLIS MICHAEL A JR	\$17,500		11271/ 441		01/19/1966

Building Information

Building 1: Section 1

Year Built:

1926

Living Area:

3,130

Replacement Cost:

\$693,358

Building Percent Good:

78

Replacement Cost

Less Depreciation:

\$540,800

Building Attributes			
Field	Description		



BZA APPLICATION FORM

DIMENSIONAL INFORMATION JESSE & KIM MOTT C/O USE/OCCUPANCY: TWO-FAMILY DWELLING APPLICANT: MICHAEL WIGGINS PRESENT 63 CLARENDEN AVE В LOCATION: ZONE: SEP -8 617 - 834 - 5903 REQUESTED USE/OCCUPANCY: ONE-FAMILY DWELLING PHONE: EXISTING REQUESTED **ORDINANCE** CONDITIONS CONDITIONS REQUIREMENTS¹ TOTAL GROSS FLOOR AREA: 2,940 SF 3,420 SF 2,000 SF (max.) LOT AREA: 4.000 SF 5,000 SF (min.) RATIO OF GROSS FLOOR AREA .735 .855 .500 TO LOT AREA: (max.) 2000 SF LOT AREA FOR EACH DWELLING UNIT: 4000 SF 2500 SF (min.) 50' - 0" 43' - 6" SIZE OF LOT: WIDTH (min.) DEPTH 5.1' 5.1' 15' Setbacks in FRONT (min.) Feet: 25' 25' REAR 25' (min.) LEFT SIDE 7.5 7.5' 7.5' (min.) 6.9 6.9 6.9 RIGHT SIDE (min.) 30.3 35" 35' SIZE OF BLDG .: HEIGHT (max.) LENGTH WIDTH RATIO OF USABLE OPEN SPACE TO LOT AREA:3) 59.89% 40% 59.24% (min.) 2 1 2 NO. OF DWELLING UNITS: (max.) 2 2 NO. OF PARKING SPACES: (min./max) NO. OF LOADING AREAS: (min.) DISTANCE TO NEAREST BLDG. (min.) ON SAME LOT: Describe where applicable, other occupancies on same lot, the size of adjacent buildings on same lot, and type of construction proposed, e.g.; wood frame, concrete, brick, steel, etc. 1. One building on lot - existing wood frame structure on lot w/ 10" concrete foundation walls and asphalt shingles.

^{1.} SEE CAMBRIDGE ZONING ORDINANCE ARTICLE 5.000, SECTION 5.30 (DISTRICT OF DIMENSIONAL

REGULATIONS).

2. TOTAL GROSS FLOOR AREA (INCLUDING BASEMENT 7'-0" IN HEIGHT AND ATTIC AREAS GREATER THAN 5') DIVIDED BY LOT AREA.

^{3.} OPEN SPACE SHALL NOT INCLUDE PARKING AREAS, WALKWAYS OR DRIVEWAYS AND SHALL HAVE A MINIMUM DIMENSION OF 15'.

63-65 Clarendon Residence

JESSE & KIM MOTT

63 CLARENDON AVENUE CAMBRIDGE MA. 02140





CITY OF CAMBRI MISPECTIONAL SERVICES

PROJECT #: 2301-6365

ARCHITECT:

CLIENTS:

GENERAL CONTRACTOR:

STRUCTURAL ENGINEER:

SAM KACHMAR

ARCHITECTS (p)617-800-6223 www.SKA-MA.com 357 HURON AVE.

JESSE & KIM MOTT

STECKEL CONSTRUCTION

SPRUHAN ENGINEERING

PROJECT NARRATIVE:



CAMBRIDGE MA, 02138


THE MOTT RESIDENCE INVOLVES THE CONVERSION OF A TWO FAMILY DWELLING INTO A SINGLE FAMILY DWELLING.

THE PROJECT INVOLVES THE INTERIOR RENOVATION OF THE HOME, WHERE THE ROOF WILL BE RAISED 56" TO THE BUILDING HEIGHT LIMIT OF 35' FROM AVERAGE GRADE TO ALLOW FOR HABITABLE SPACE AT THE 3RD FLOOR LEVEL.

ADDITIONALLY, THE PREXISTING NONCONFORMING FAR WILL INCREASE BY .113 DUE TO THE RAISING OF THE ROOF AND THE ADDTIONAL FRAMING OF ROOF AWNINGS AT THE FRONT AND REAR PORCH.

AT THE FRONT OF THE HOME, THE STAIRS WILL BE REFRAMED AND THE FENESTRATION ALONGSIDE RIGHTSIDE ELEVATION WILL BE RELOCATED.

BZA SUBMISSION SET 09/08/2023

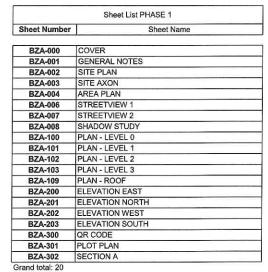

LAMINATE, LAMINATED

LIGHT WEIGHT

MDF MEDIUM DENSITY FIBER
MECH MECHANICAL

MECHANICAL
MEDIUM
MANUFACTURER
MINIMUM
MISCELLANEOUS
MOUNTED
METAL
NORTH
NOT APPLICABLE
NOT IN CONTRACT
NOMINAL
NOT TO SCALE
ON CENTER

ON CENTER
OUTSIDE DIAMETER
OPPOSITE HAND

OVHD OVERHEAD
OZ OUNCE (S)
PATT PATTERN (ED
PERF PERFORATEI

PERF PERFORATED
PERP PERPENDICULAR
PLAM PLASTIC LAMINAT
PLYWD PLYWOOD
PNT PAINT, PAINTED
PR PAIR

RO ROUGH OPENING
S SOUTH
SCHED SCHEDULE

SPEC SPECIFICATION SQ SOURCE
SS, SST STAINLESS STEEL
STC SOUND TRANSMIS
STL STEEL
STOR STORAGE

SIMIL AR

SQUARE FEET SQUARE INCHES

OPPOSITE HAND
OPPOSITE
ORIENTED STRANDBOAR

PREFAB PREFABRICATE, PREFABRICATED
QTY QUANTITY
RAD RADIUS
RBR RUBBER

ROOF DRAIN
REFERENCE
REFRIGERATE, REFRIGERATOR
REINFORCE, REINFORCED

REQUIRE REVISION, REVISE, REVISED

UNDERSIDE OF UNLESS OTHERWISE NOTED

WEIGHT INDICATES TIMES OR BY

IGHT GAGE METAL FRAMING

A RRDEVIATIONS

#	NUMBER OR POUND
8,+	AND
@	AT
ADJ	ADJUSTABLE
AFF	ABOVE FINISH FLOOR
ALUM	ALUMINUM
APPROX	APPROXIMATELY
ARCH	ARCHITECTURAL
AVB	AIR AND VAPOR BARRIER
BD	BOARD
BIT	BITUMINOUS
BLDG	BUILDING
BSMT	BASEMENT
BTWN	BETWEEN
CF	CUBIC FEET
CI	CUBIC INCHES
CJ	CONTROL JOINT
CL	CENTERLINE
CLG	CEILING
CLR	CLEAR OR CLEARANCE
CMU	CONCRETE MASONRY UNIT
COL	COLUMN
CONC	CONCRETE
CONT	CONTINUOUS
CORR	CORRIDOR, CORRUGATED
CTR	CENTER
D	DEPTH, DEEP
DBL	DOUBLE
DEMO	DEMOLISH, DEMOLITION
DIA	DIAMETER
DIM	DIMENSION
DN	DOWN
DTL	DETAIL
DW	DISHWASHER
E	EAST
EA	EACH
EJ	EXPANSION JOINT
EL	ELEVATION (GRADE)
ELEC	ELECTRICAL
ELEV	ELEVATION (FACADE)
EOS	EDGE OF SLAB
EQ	EQUAL, EQUIPMENT, EQUIP
ETR	EXISTING TO REMAIN
EXG	EXISTING
EXP	EXPOSED
EXT	EXTERIOR
FAB	FABRICATE, FABRICATION
FD	FLOOR DRAIN
FF	FINISHED FLOOR
FL	FLOOR
FOW	FACE OF WALL
FT	FEET, FOOT
GA	GAUGE
GALV	GALVANIZED
GL	GLASS, GLAZING, GLAZED
GWB	GYPSUM WALLBOARD, BACKING BOARD
GYP	GYPSUM
H	HIGH
HDWD	HARDWOOD
HM	HOLLOW METAL
HORIZ	HORIZONTAL
HVAC	HEATING, VENTILATING & AIR CONDITIONING
IN	INCH, INCHES
INCL	INCLUDE, INCLUDED
INT	INTERIOR
JT	JOINT


0

MATERIALS

MATERIALS	
	EARTH
	CONCRETE
#1005 9/000 9/1000 40	GRAVEL
	SAND
	GYPSUM BOARD OR SHEATHING
	MASONRY - BRICK
	MASONRY - CONCRETE BLOCK
	WOOD - FINISH - END GRAIN
	WOOD - FINISH - FACE
	WOOD - ROUGH - BLOCKING (CONTINUOUS MEMBERS)
	WOOD - ROUGH - BLOCKING (INTERMEDIATE MEMBERS)
	INSULATION - RIGID
	INSULATION - BATT OR MINERAL WOOL
	ACOUSTIC TILE, PANEL, OR PLANK
	PLYWOOD
	CUT STONE
	PARTICLE BOARD OR FIBERBOARD
	WOOD - FINISH - FACE WOOD - ROUGH - BLOCKING (CONTINUOUS MEMBERS) WOOD - ROUGH - BLOCKING (INTERMEDIATE MEMBERS) INSULATION - RIGID INSULATION - BATT OR MINERAL WOOL ACOUSTIC TILE, PANEL, OR PLANK PLYWOOD CUT STONE PARTICLE BOARD OR

2 - MATERIALS Copy 2 1 1/2" = 1'-0" FEP (x2) **FUS** BAS UBM

SYMBOLS

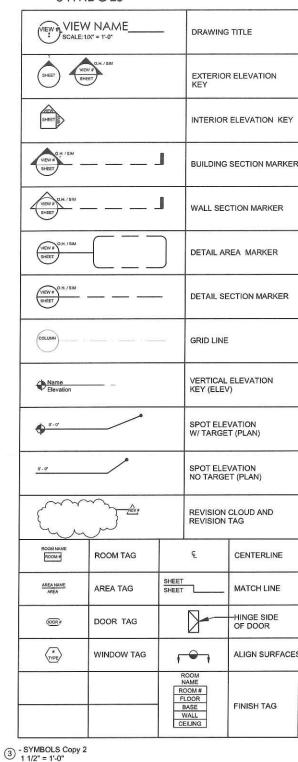

GENERAL NOTES

- 1. ALL WORK SHALL BE CONSIDERED NEW, UNLESS OTHERWISE INDICATED.
- NOT SCALE DRAWINGS
 VERIFY DIMENSIONS, GRADES, BOUNDARIES, AND CONSTRUCTION AND IMMEDIATELY REPORT ANY DISCREPANCIES BEFORE PROCEEDING WITH THE WORK
- 4. TO THE EXTENT PRACTICABLE, VERIFY DIMENSIONS AND FIELD CONDITIONS AT THE SITE PRIOR TO THE BID SUBMISSION. CONFLICTS, OMISSIONS AND DISCREPANCIES WITHIN THE CONTRACT DOCUMENTS SHALL BE REPORTED IN WRITING TO THE ARCHITECT, IN ACCORDANCE WITH THE CONTRACT DOCUMENTS, PRIOR TO THE BID SUBMISSION. THE CONTRACTOR WARRANTS, BY TENDERING HIS BID, THAT THE WORK IS BUILDABLE AS SHOWN.

 1. LAYOUT ALL WORK WITHIN THE CONFINES OF EXISTING CONSTRUCTION AND RESOLVE DISCREPANCIES PRIOR TO INITIATION
- OF NEW WORK
- ARCHITECT IS NOT RESPONSIBLE FOR CONSTRUCTION THAT IS STARTED PRIOR TO PERMIT BEING ISSUED.
- 7. DIMENSIONS, NOTES, FINISHES AND FIXTURES SHOWN ON TYPICAL FLOOR PLANS, SECTION OR DETAILS SHALL APPLY TO SIMILAR, SYMMETRICAL OR OPPOSITE HAND PLANS SECTIONS OR DETAILS, UNLESS NOTED OTHERWISE.
- NILESS NOTED OTHERWISE.

 TYPICAL OR "TYP" SHALL MEAN THAT THE CONDITION IS
 REPRESENTATIVE FOR SIMILAR CONDITIONS THROUGHOUT, UNLESS NOTED OTHERWISE. DETAILS ARE USUALLY KEYED AND NOTED "TYP" ONLY ONE TIME, WHEN THEY FIRST OCCUR.

 9. IMMEDIATELY NOTIFY THE ARCHITECT IN WRITING OF ANY
- DISCREPANCIES BETWEEN PROJECT MANUAL, LARGE SCALE DRAWINGS, SMALL SCALE DRAWINGS AND DETAILS. THE CONTRACTOR SHALL NOT PROCEED WITH AFFECTED WORK UNTIL ARCHITECT PROVIDES CLARIFICATION.
- 10. PARTITIONS ARE DIMENSIONED FROM FINISHED FACE TO FINISHED FACE UNLESS OTHERWISE NOTED. DIMENSIONS TO MASONRY ARE TO ACTUAL FINISHED FACE, UNLESS OTHERWISE NOTED.
- 11. VERIFY THAT DRAWINGS ARE THE LATEST ISSUE PRIOR TO COMMENCING CONSTRUCTION. THE GENERAL CONTRACTOR SHALL BE RESPONSIBLE FOR COMMUNICATING AND DISTRIBUTING ALL CONSTRUCTION DOCUMENT UPDATES TO ALL TRADES.
- 12. WORK SHALL CONFORM TO THE REQUIREMENTS OF APPLICABLE STATE, FEDERAL AND CITY/COUNTY CODES. STATE AND FEDERAL CODES ARE TO TAKE PRECEDENCE OVER THE DRAWINGS AND SPECIFICATIONS. IF ANY DISCREPANCY IS NOTED, IMMEDIATELY INFORM THE ARCHITECT, PRIOR TO PROCEEDING WITH THE WORK.

 13. FILE, OBTAIN AND PAY FEES FOR BUILDING DEPARTMENT PERMITS, CONTROLLED INSPECTIONS, OTHER AGENCY APPROVALS AND
- PERMITS WHERE REQUIRED, AND FINAL WRITE-OFFS FOR PROJECT COMPLETION. COPIES OF TRANSACTIONS SHALL BE FORWARDED TO
- THE OWNER OR OWNER'S REPRESENTATIVE.

 14. EXECUTE INSPECTIONS NECESSARY TO OBTAIN A CERTIFICATE OF
- OCCUPANCY.

 15. WORK AREA SHALL BE MAINTAINED, CLEAN AND FREE OF DEBRIS AT ALL TIMES
- 16. PATCH ALL SURFACES TO MATCH ADJACENT IN A MANNER SUITABLE TO RECEIVE FINISHES.
- TO RECEIVE FINISHES.

 17. PATCH, REPAIR AND FINISH ALL SURFACES IN AREAS OUTSIDE OF THE EXISTING SCOPE THAT ARE DISTURBED AS A RESULT OF THE WORK.

 18. COORDINATE AND PROVIDE BLOCKING AND STRAPPING WITHIN
- PARTITIONS FOR MILLWORK AND OTHER WALL ATTACHED ITEMS.

 19. APPLY, INSTALL, CONNECT, CLEAN AND/OR CONDITION
- MANUFACTURED ARTICLES, MATERIALS AND/OR EQUIPMENT PER MANUFACTURER'S INSTRUCTIONS. IN CASE OF CONFLICT BETWEEN
 MANUFACTURER'S INSTRUCTIONS AND THE CONTRACT DOCUMENTS, THE CONTRACTOR SHALL OBTAIN WRITTEN CLARIFICATION FROM THE ARCHITECT BEFORE PROCEEDING.
- 20. GLASS 18" OR LESS FROM FLOOR LINE OR ADJACENT TO A DOOR SWING SHALL BE SAFETY GLASS AS REQUIRED BY APPLICABLE CODE(S). THE CONTRACTOR SHALL BE RESPONSIBLE FOR PROVIDING." SAFETY GLASS, UNLESS OTHERWISE NOTED, TO COMPLY WITH BUILDING AND LIFE SAFETY CODES, INDUSTRY STANDARDS AND OTHER APPLICABLE FEDERAL AND STATE CODES.
- 21 FLASHING AT EXTERIOR WALLS SHALL BE INSTALLED WITH SEALED JOINTS, SEALED PENETRATIONS AND ENDS TURNED UP. IT SHALL BE FABRICATED AND INSTALLED TO ENSURE THAT MOISTURE IN WALLS WILL BE DIRECTED TO WICKS AND WEEP HOLES. 22. COORDINATE ALL DIMENSIONS CONCERNING
- DOORS/PANELS/WINDOWS, STAIRS AND THEIR OPENINGS WITH PRODUCT MANUFACTURERS PRIOR TO FABRICATION AND
- CONSTRUCTION.
 23. PROVIDE WEATHERSTRIP AT EXTERIOR DOORS.
- 24. PROVIDE FLASHING AND/OR SEALANT AT OPENINGS IN ROOF OR WALLS TO ENSURE A WEATHERTIGHT BUILDING.

 25. LOCATE THERMOSTATS ADJACENT TO SWITCH PLATES WHERE
- POSSIBLE. VERIFY LOCATION WITH THE ARCHITECT PRIOR TO INSTALLATION TO AVOID CONFLICTS WITH BUILT-INS OR SYSTEMS
- FURNITURE OR DESIGN ELEMENTS.

 26. ALIGN OUTLETS, WALL SWITCHES, TEL-DATA JACKS, ETC., INDICATED TO BE MOUNTED AT NEAR EQUIVALENT ELEVATIONS.

 27. ALL DOORS SHALL BE LOCATED 6" OFF THE ADJACENT PARTITION OR ONE MASONRY COURSE AT CMU PARTITIONS, UNLESS NOTED
- 28. DURING DEMOLITION AND CONSTRUCTION PROTECT ALL EXISTING
- FINISHES TO REMAIN.
 29. ALL WOOD SHALL BE FSC CERTIFIED.

- 30. ALL WOOD FRAMING SIZES ARE BASED ON SPF-SS 31. ALL WOOD IN CONTACT WITH CONCRETE OR MASONRY SHALL BE PRESSURE TREATED (P.T.).
 32. CORRECT ALL DEFECTS FOUND IN EXISTING BUILDING WHICH
- INTERFERE WITH NEW CONSTRUCTION. THIS INCLUDES BUT IS NOT LIMITED TO UNEVEN SURFACES AND FINISHES AT GWB.
- 1 1/2" = 1'-0"



SAM KACHMAR ARCHITECTS

(p) 617-800-6223 www.SKA-MA.com 357 HURON AVE.

CAMBRIDGE MA. 02138

REGISTRATIONS

NOT FOR CONSTRUCTION

NOTES GENERAL

KIM MOT

ంర

JESSE


Clarendon Residence AVENUE A. 02140 63 CLARENDON A CAMBRIDGE MA. ΜĀ. -65

CONSTRUCTION **DOCUMENTS** Project Status 2301-6365 Project number Date 09/08/2023 Drawn by Author Checker

1 1/2" = 1'-0"





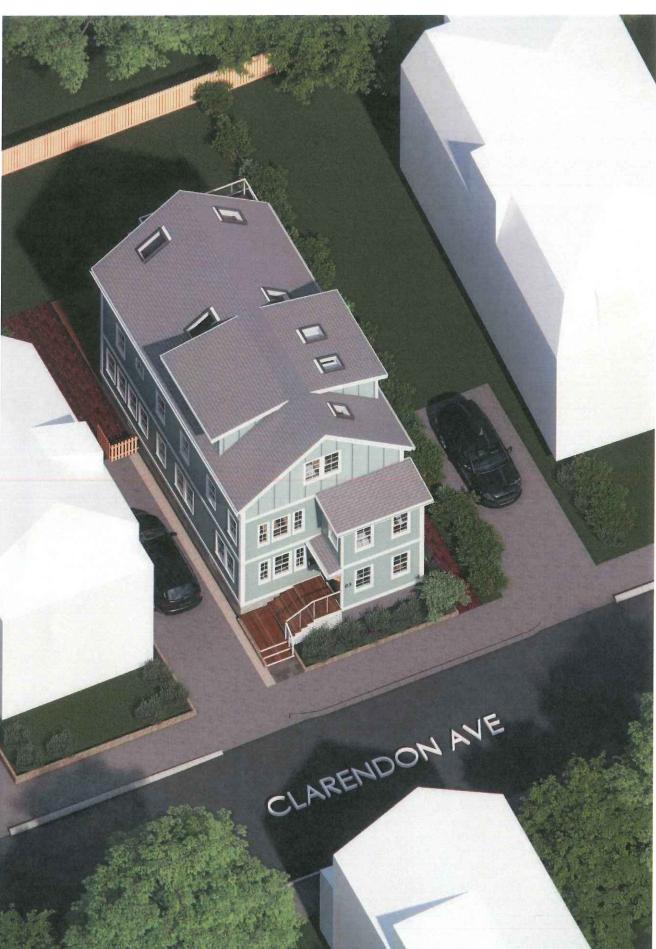



SAM KACHMAR ARCHITECTS

(p) 617-800-6223 www.SKA-MA.com 357 HURON AVE. CAMBRIDGE MA, 02138

REGISTRATIONS:

NOT FOR CONSTRUCTION

SITE AXON


JESSE & KIM MOTT

63-65 Clarendon Residence

63 CLARENDON AVENUE CAMBRIDGE MA. 02140

CONSTRUCTION
DOCUMENTS
2301-6365
09/08/2023
Author
Checker

BZA-003

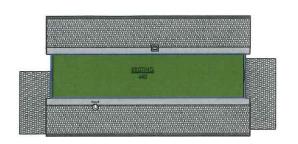


4 EXISTING - AREA PLAN - LEVEL 3 1" = 10'-0"

3 EXISTING - AREA PLAN - LEVEL 2 1" = 10'-0"

EXISTING FAR

EXISTING

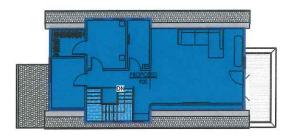

8 PROPOSED - AREA PLAN - LEVEL 3

PROPOSED FAR

PROPOSED




EXISTING

EXISTING FAR

PROPOSED FAR


PROPOSED

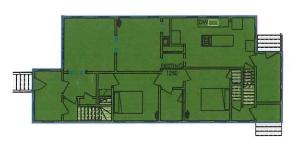

② EXISTING - AREA PLAN - LEVEL 1 1" = 10'-0"

EXISTING FAR

EXISTING

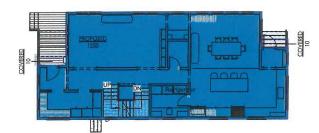


6 PROPOSED - AREA PLAN - LEVEL 1

PROPOSED FAR

COVERED


PROPOSED

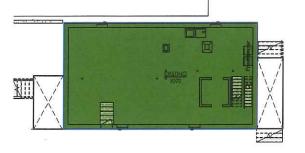

1" = 10'-0"

EXISTING FAR

EXISTING

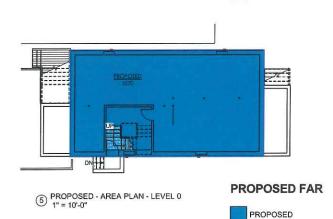

Existing FAR Area Comments 1070 SF EXISTING LEVEL 0 EXISTING LEVEL 1 1250 SF **EXISTING LEVEL 2** 1250 SF EXISTING LEVEL 3 440 SF

EXISTING ABOVE GRADE FAR: EIXSTING BASEMENT FAR*:

* BASEMENT AREA EXEMPT

TOTAL EXISTING FAR: 4,010 SF

Proposed FAR			
Level	Area	Comments	
EXISTING LEVEL 0	1070 SF		
EXISTING LEVEL 1	1250 SF		
EXISTING LEVEL 1	10 SF		
EXISTING LEVEL 1	10 SF		
EXISTING LEVEL 2	1250 SF		
EXISTING LEVEL 3	900 SF		

PROPOSED ABOVE GRADE FAR: 3,420 SF PROPOSED BASEMENT FAR*: 1,070 SF * BASEMENT AREA EXEMPT

TOTAL PROPOSED FAR:

4,490 SF

2,940 SF

1,070 SF

ZONE DISTRICT - RESIDENCE B:

SINGLE- & TWO-FAMILY DETACHED TOWNHOUSE DWELLINGS

OPEN SPACE CALCULATIONS

LOT SIZE: 4,000 SQ FT

REQUIRED OPEN SPACE (MIN): 40.00% EXISTING OPEN SPACE: 59.89% PROPOSED OPEN SPACE: 59.24%

PROPOSED DECREASED OPEN: 00.65%

FAR CALCULATION

9 PROPOSED - LOT PLAN 1/8" = 1'-0"

REQUIRED FAR: 0.500 0.735 EXISTING FAR: PROPOSED FAR: 0.855

PROPOSED INCREASE FAR:

SET BACKS

REQUIRED FRONT YARD SETBACK: 15' **EXISTING SETBACK:** 5.1' PROPOSED SETBACK: 5.1' REQUIRED LEFT SIDE YARD SETBACK: 7.5' MIN (SUM OF 20) **EXISTING SETBACK:** 11.58 11.58

Zoning Districts


PROPOSED SETBACK: REQUIRED RIGHT SIDE YARD SETBACK: **EXISTING SETBACK:**

PROPOSED SETBACK: **25**' 25' REQUIRED REAR YARD SETBACK: **EXISTING SETBACK:** PROPOSED SETBACK:

BUILDING HEIGHT FROM AVG GRADE

REQUIRED BUILDING HEIGHT: 35' 30.3 EXISTING HEIGHT: PROPOSED HEIGHT: 35.0

0.120

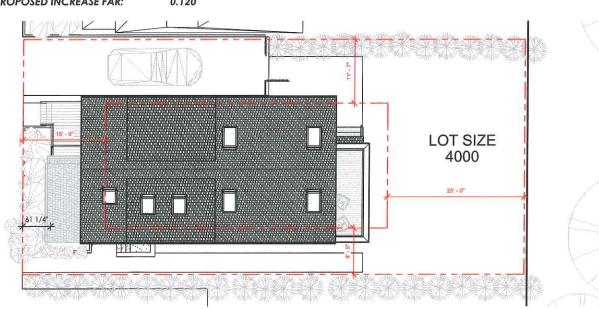

SAM KACHMAR ARCHITECTS

(p) 617-800-6223 www.SKA-MA.com 357 HURON AVE. CAMBRIDGE MA, 02138

REGISTRATIONS:

NOT FOR CONSTRUCTION

PLAN AREA

& KIM MOTI

JESSE ,

7.5' MIN (SUM OF 20)

8.42'

8.42'


25'

Clarendon Residence 63 CLARENDON AVENUE CAMBRIDGE MA. 02140 65

CONSTRUCTION **DOCUMENTS** 2301-6365 Project number Date 09/08/2023 Drawn by Author Checker

BZA-004

As indicated

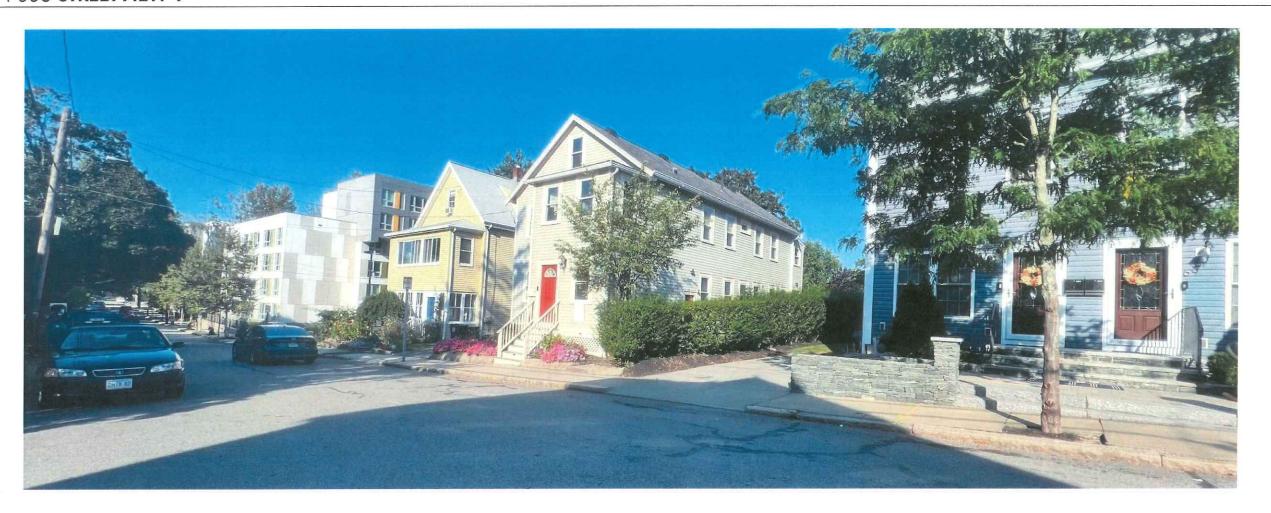





9 2023 SAM KACHMAR ARCHITECTS

M KACHMAR ARCHITECT

(p) 617-800-6223 www.SKA-MA.com 357 HURON AVE. CAMBRIDGE MA, 02138

NOT FOR CONSTRUCTION

STREETVIEW 1

JESSE & KIM MOTT

ndon Residence

3-65 Clarendon Reside

63 CLARENDON AVENUE CAMBRIDGE MA. 02140

Project Status	CONSTRUCTION DOCUMEN
Project number	2301-63
Date	09/08/20
Drawn by	Auth

BZA-006

Scale

2002310-00-01







(p) 617-800-6223 www.SKA-MA.com 357 HURON AVE. CAMBRIDGE MA, 02138

NOT FOR CONSTRUCTION


STREETVIEW 2


JESSE & KIM MOTT

63 CLARENDON AVENUE CAMBRIDGE MA. 02140

CONSTRUCTION
DOCUMENT
2301-636
09/08/202
Autho
Checke


BZA-007

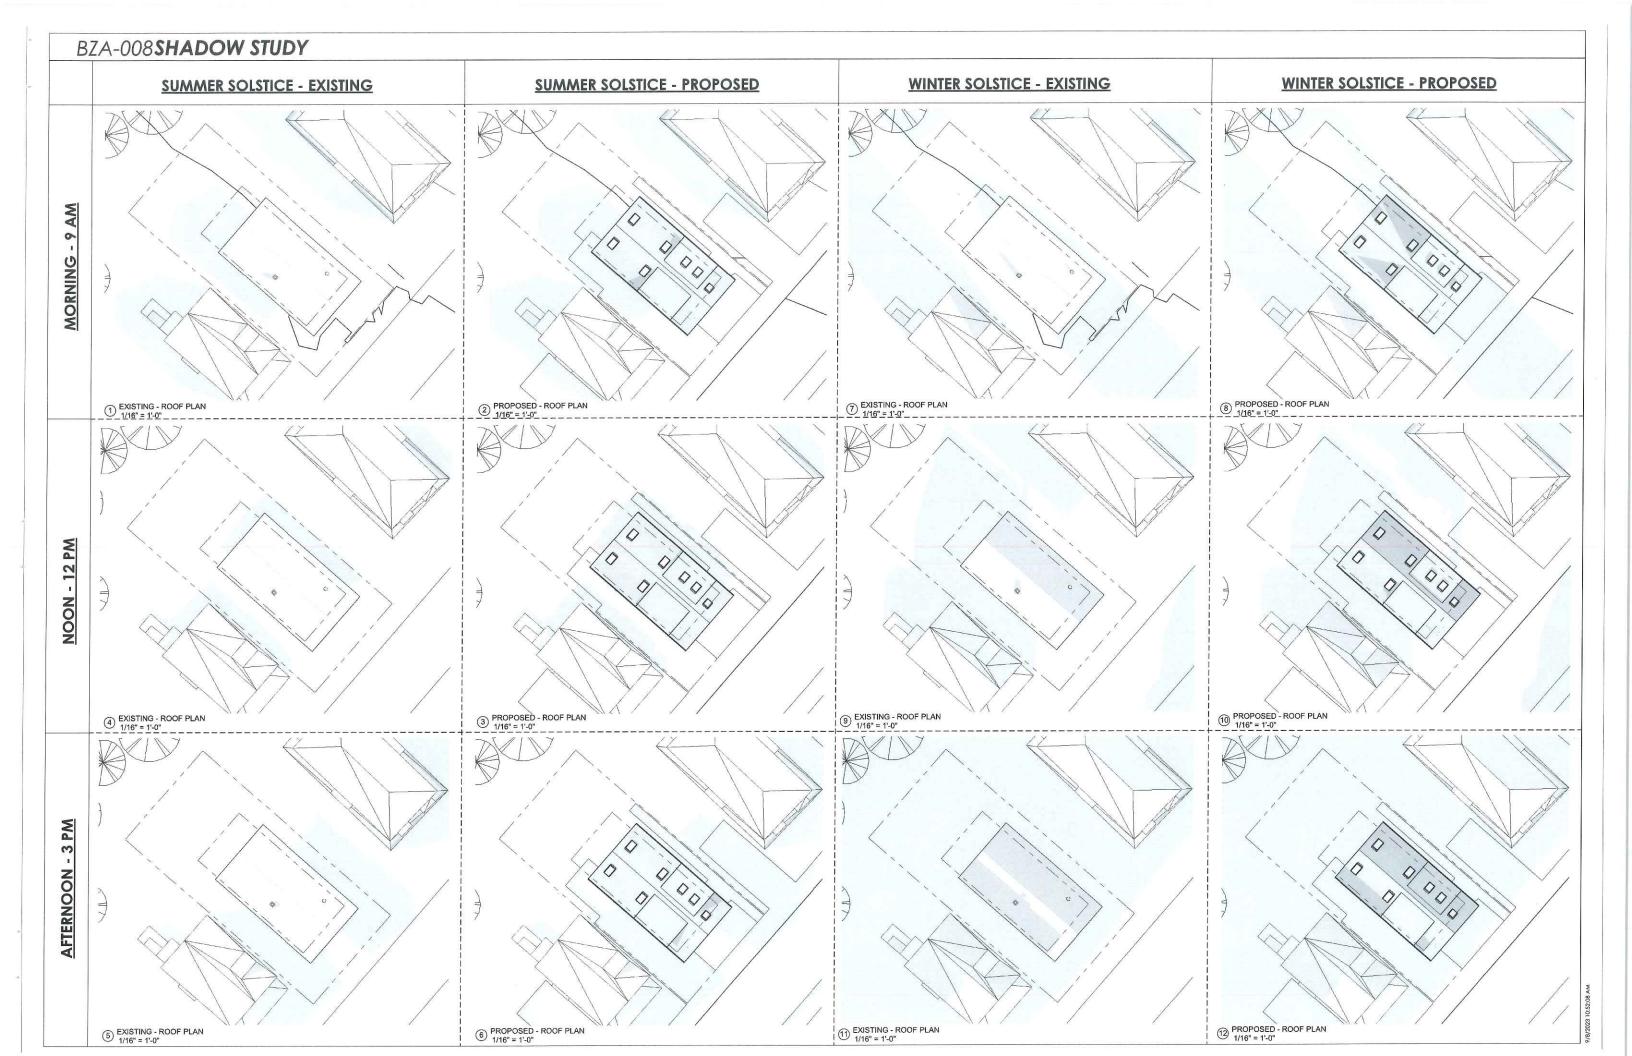

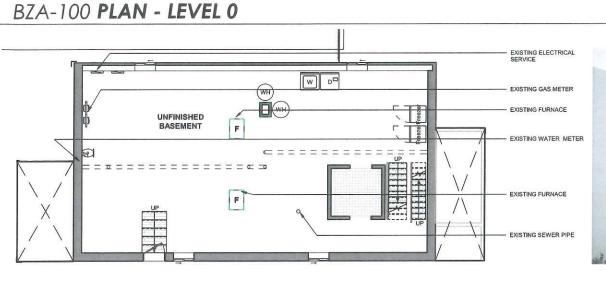

1 EXISTING - LEVEL 0 3/16" = 1'-0"



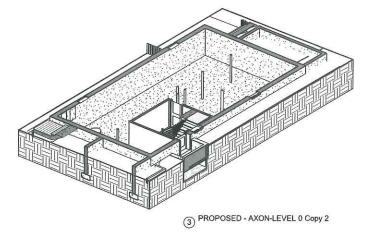



SAM KACHMAR ARCHITECTS

(p) 617-800-6223 www.SKA-MA.com 357 HURON AVE. CAMBRIDGE MA, 02138

NOT FOR CONSTRUCTION

PLAN - LEVEL

JESSE & KIM MOTT


63-65 Clarendon Residence


63 CLARENDON AVENUE CAMBRIDGE MA. 02140

CONSTRUCTION DOCUMENTS Project Status Project number 2301-6365 09/08/2023 Author Checker

BZA-100 As indicated

LIMITED WORK AT THIS LEVEL

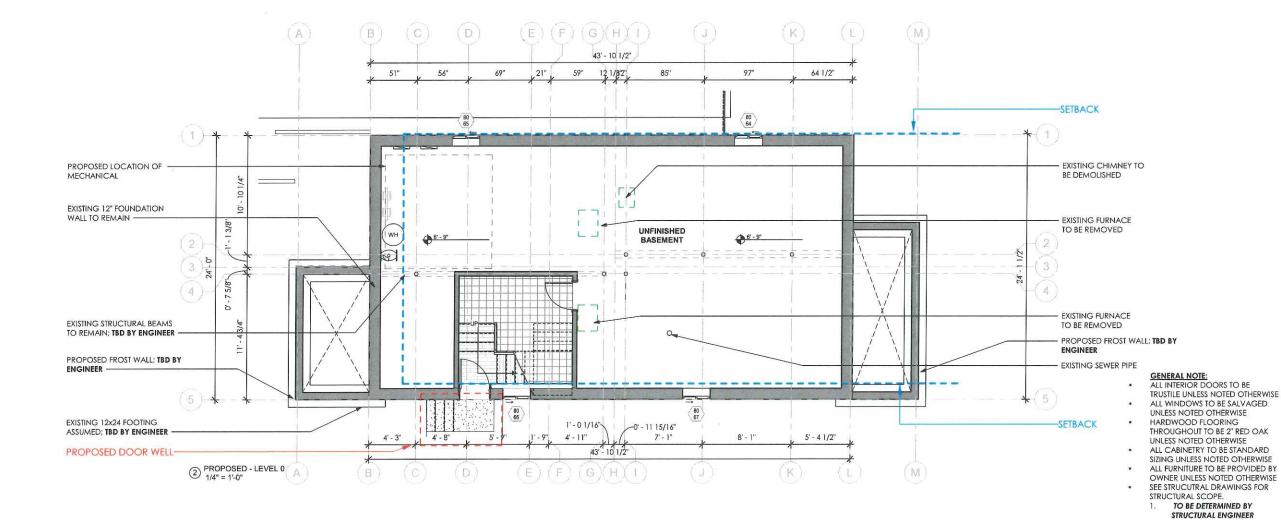

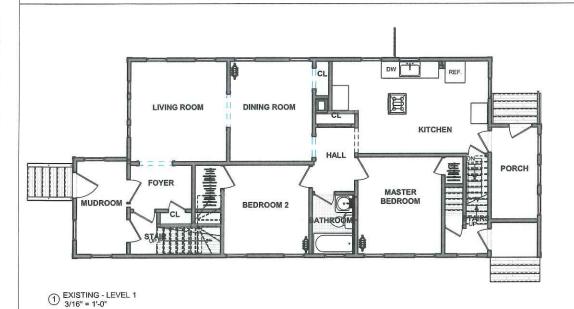







SAM KACHMAR ARCHITECTS

(p) 617-800-6223 www.SKA-MA.com 357 HURON AVE. CAMBRIDGE MA, 02138

REGISTRATIONS:

NOT FOR CONSTRUCTION

PLAN - LEVEL

63-65 Clarendon Residence


JESSE & KIM MOTT

CONSTRUCTION **DOCUMENTS** Project number Date 2301-6365 09/08/2023 Author Checker

63 CLARENDON AVENUE CAMBRIDGE MA. 02140

As indicated


TO BE DETERMINED BY STRUCTURAL ENGINEER

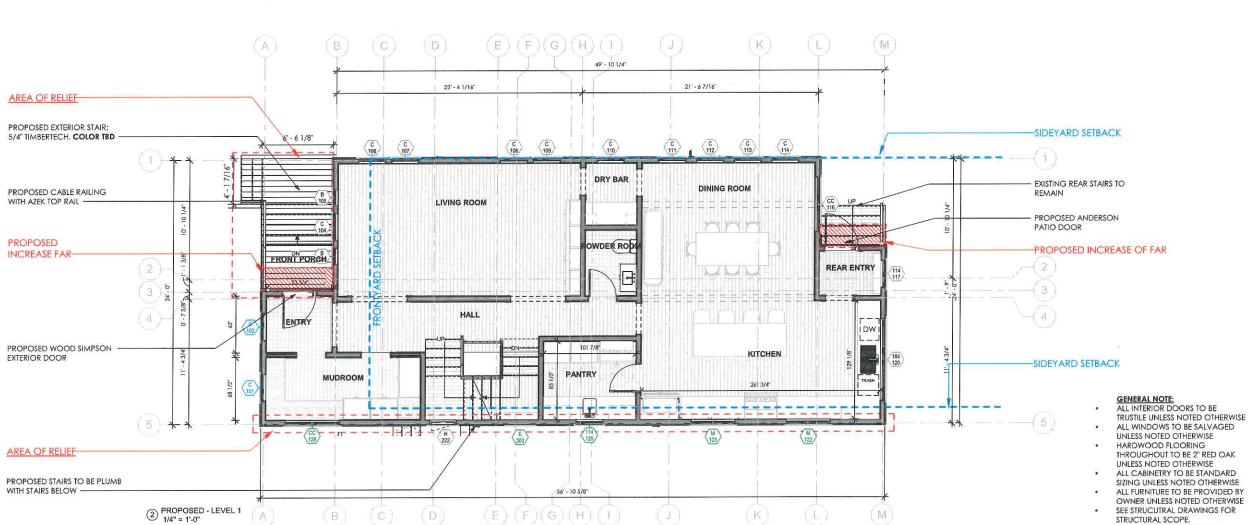

1 EXISTING - LEVEL 2 3/16" = 1'-0"





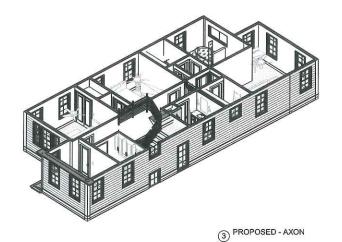

SAM KACHMAR ARCHITECTS

(p) 617-800-6223 www.SKA-MA.com 357 HURON AVE. CAMBRIDGE MA, 02138

NOT FOR CONSTRUCTION

PLAN - LEVEL

JESSE & KIM MOTT

Clarendon Residence


63 CLARENDON AVENUE CAMBRIDGE MA. 02140 63-65


CONSTRUCTION DOCUMENTS Project Status Project number 2301-6365 09/08/2023 Author Checker

BZA-102


As indicated

TO BE DETERMINED BY STRUCTURAL ENGINEER

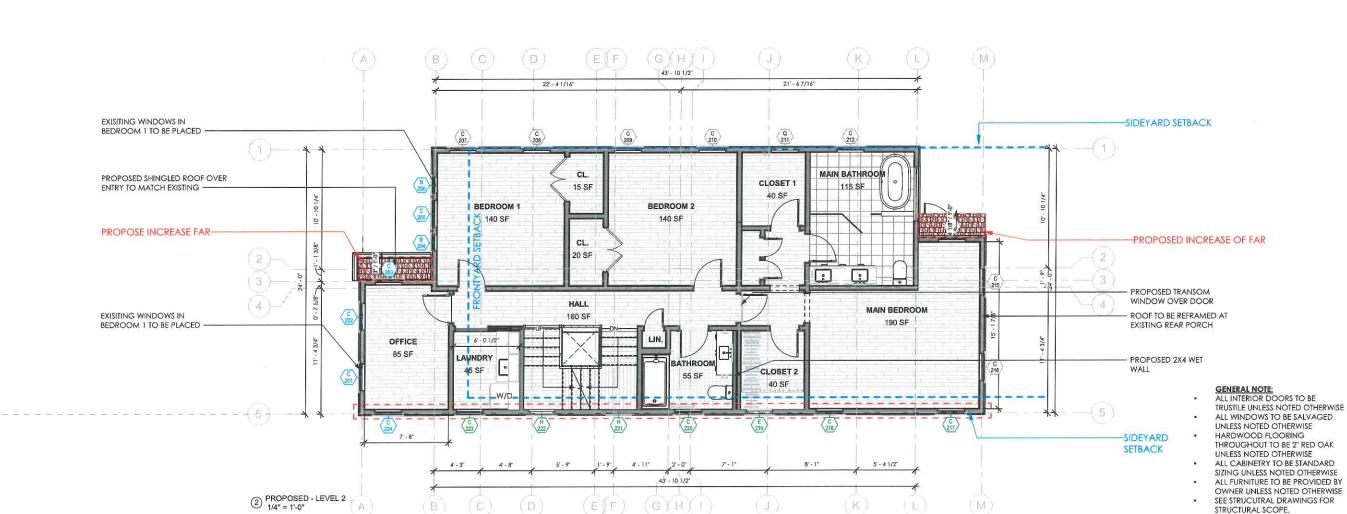

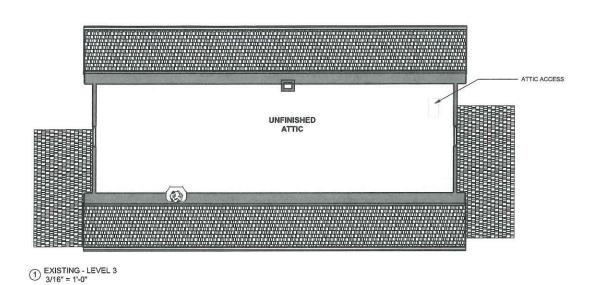



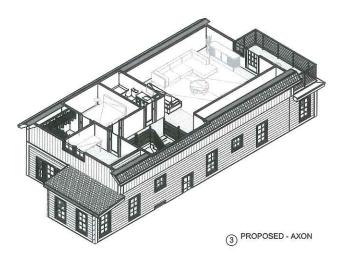



SAM KACHMAR ARCHITECTS

(p) 617-800-6223 www.SKA-MA.com 357 HURON AVE. CAMBRIDGE MA, 02138

REGISTRATIONS:

NOT FOR CONSTRUCTION

PLAN - LEVEL


63-65 Clarendon Residence JESSE & KIM MOTT

CONSTRUCTION Project Status 2301-6365 09/08/2023 Author Checker

63 CLARENDON AVENUE CAMBRIDGE MA. 02140

STRUCTURAL SCOPE.


TO BE DETERMINED BY STRUCTURAL ENGINEER

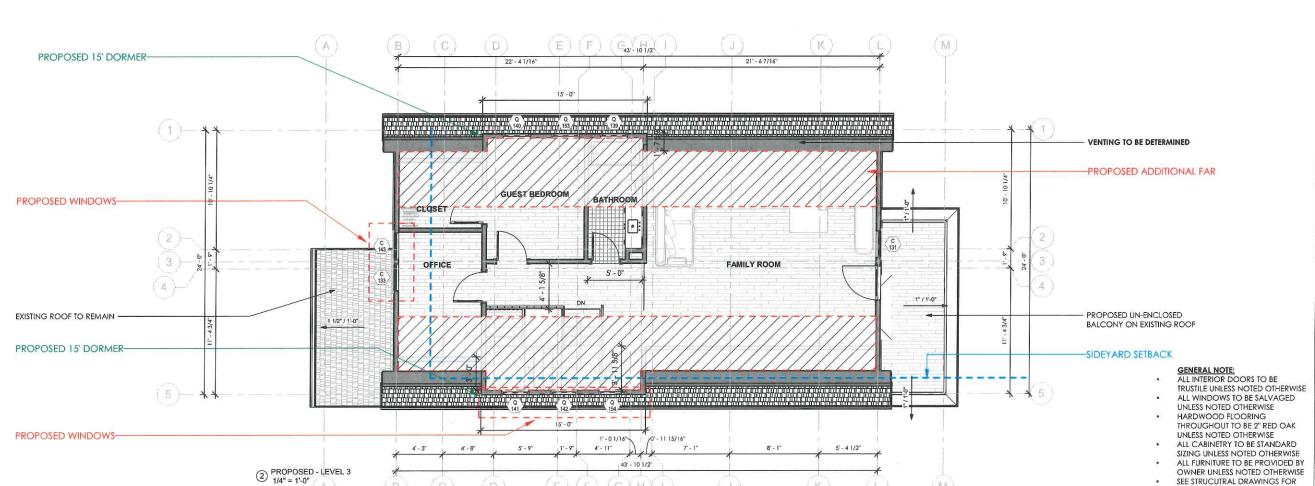

(E)(F)(G(H(I)

(B)



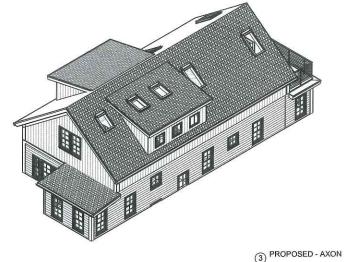

SAM KACHMAR ARCHITECTS

(p) 617-800-6223 www.SKA-MA.com 357 HURON AVE. CAMBRIDGE MA, 02138

NOT FOR CONSTRUCTION

PLAN - ROOF

63-65 Clarendon Residence JESSE & KIM MOTT

63 CLARENDON AVENUE CAMBRIDGE MA. 02140

As indicated


CONSTRUCTION
DOCUMENTS
2301-6365
09/08/2023
Author
Checker

BZA-109

SIZING UNLESS NOTED OTHERWISE ALL FURNITURE TO BE PROVIDED BY OWNER UNLESS NOTED OTHERWISE SEE STRUCUTRAL DRAWINGS FOR STRUCTURAL SCOPE. TO BE DETERMINED BY STRUCTURAL ENGINEER

2 EXISTING - ROOF PLAN 3/16" = 1'-0"

1) PROPOSED - ROOF PLAN

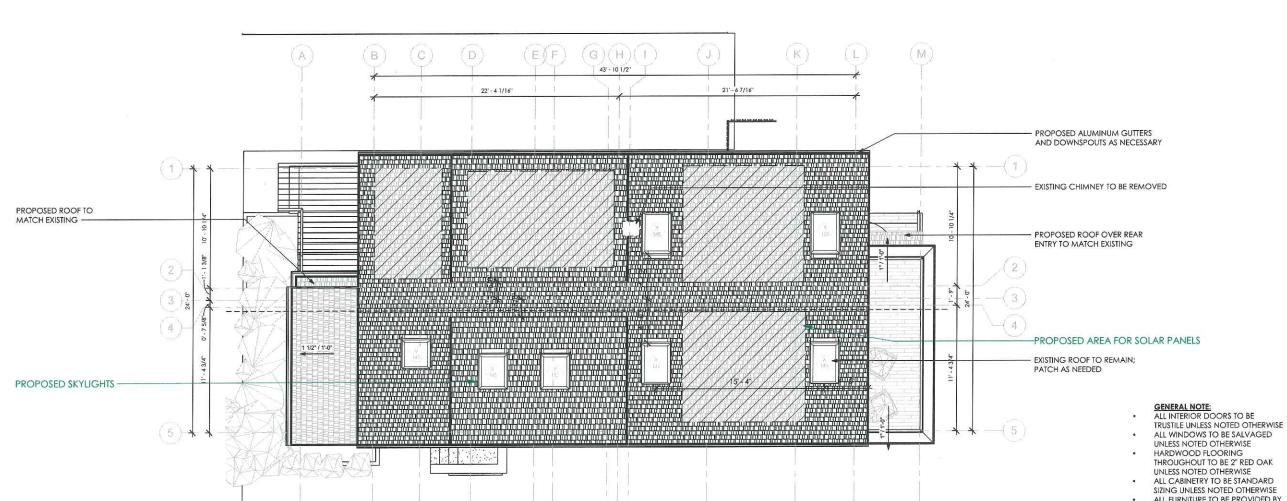

43' - 10 1/2"


(G)(H)(

5' - 4 1/2"

(M)

PROPOSED

EXISTING

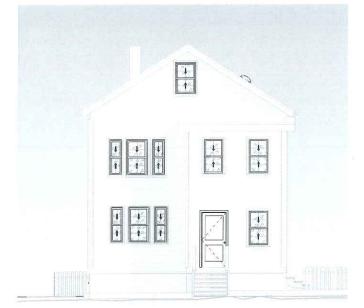





SAM KACHMAR ARCHITECTS

(p) 617-800-6223 www.SKA-MA.com 357 HURON AVE. CAMBRIDGE MA, 02138

REGISTRATIONS

NOT FOR CONSTRUCTION


ELEVATION EAST

JESSE & KIM MOTT

63-65 Clarendon Residence

CONSTRUCTION DOCUMENTS Project Status 2301-6365 Date 09/08/2023 Checker

① EXISTING - EAST ELEVATION 3/16" = 1'-0"

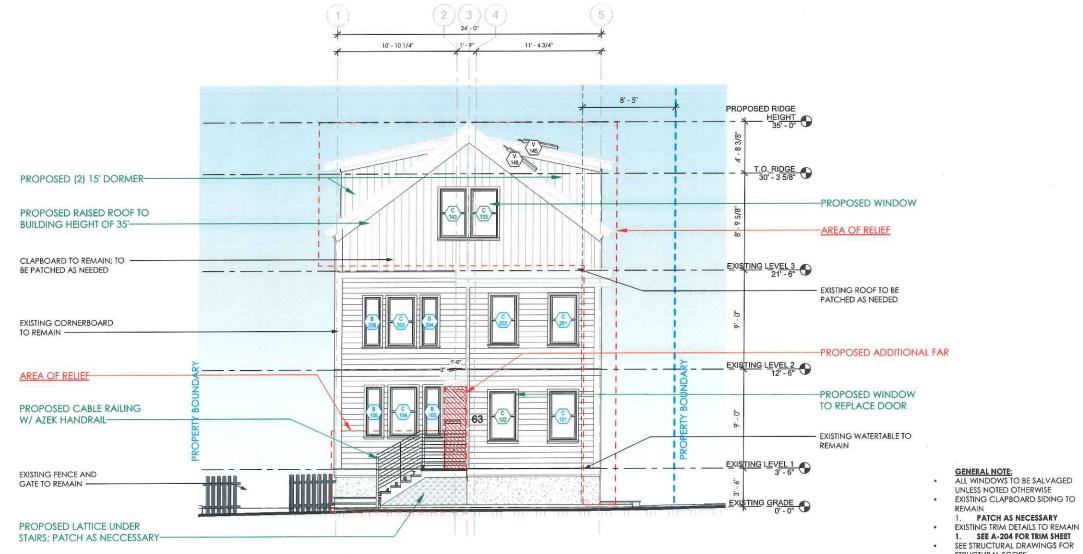

STRUCTURAL ENGINEER

SEE STRUCTURAL DRAWINGS FOR STRUCTURAL SCOPE. TO BE DETERMINED BY

PROPOSED - EAST ELEVATION 1/4" = 1'-0"

63 CLARENDON AVENUE CAMBRIDGE MA. 02140

EXISTING

PROPOSED - NORTH ELEVATION
1/4" = 1'-0"



EXISTING



SAM KACHMAR ARCHITECTS

(p) 617-800-6223 www.SKA-MA.com 357 HURON AVE. CAMBRIDGE MA, 02138

NOT FOR CONSTRUCTION

ELEVATION NORTH

63-65 Clarendon Residence

63 CLARENDON AVENUE CAMBRIDGE MA. 02140 JESSE & KIM MOTT CONSTRUCTION DOCUMENTS 2301-6365 09/08/2023 Author

Checker

As indicated

SEE STRUCTURAL DRAWINGS FOR STRUCTURAL SCOPE.

1. TO BE DETERMINED BY

STRUCTURAL ENGINEER

0 4. 1 4 1. 20 ① EXISTING - NORTH ELEVATION 3/16" = 1'-0"

PROPOSED





PROPOSED



EXISTING



EXISTING LEVEL 1

EXISTING GRADE

EXISTING STAIRS TO REMAIN

SAM KACHMAR ARCHITECTS

(p) 617-800-6223 www.SKA-MA.com 357 HURON AVE. CAMBRIDGE MA, 02138

NOT FOR

63-65 Clarendon Residence

CONSTRUCTION DOCUMENTS 2301-6365 09/08/2023 Author

CONSTRUCTION

ELEVATION WEST

JESSE & KIM MOTT

63 CLARENDON AVENUE CAMBRIDGE MA. 02140

Checker

As indicated

① EXISTING - WEST ELEVATION 3/16" = 1'-0"

11' - 4 3/4" 10' - 10 1/4" PROPOSED RIDGE PROPOSED WINDOW T.O. RIDGE 30" - 3 5/8" • EXISTING ROOF TO REMAIN; PATCH REFRAME ROOF AND WALL AT AS NEEDED EXISTING LOCATION EXISTING CORNER AND TRIMBOARD TO REMAIN; MATCH EXISTING AS NECCESSARY EXISTING LEVEL 3 EXISTING CLAPBOARD TO REMAIN; TO BE PATCH AND REPAINTED P 127 -PROPOSED SHINGLED ROOF OVER BACK ENTRY EXISTING LEVEL 2 12' - 6" PROPOSED ADDITIONAL FAR INFILL WALL AS NEEDED PROPOSED DOUBLE HARVEY

PROPOSED TRIPLE HARVEY DOUBLE-HUNG WINDOWS

PROPOSED - WEST ELEVATION
1/4" = 1'-0"

TO BE DETERMINED BY STRUCTURAL ENGINEER

GENERAL NOTE:
ALL WINDOWS TO BE SALVAGED
UNLESS NOTED OTHERWISE
EXISTING CLAPBOARD SIDING TO

REMAIN

1. PATCH AS NECESSARY
EXISTING TRIM DETAILS TO REMAIN
1. SEE A-204 FOR TRIM SHEET
SEE STRUCTURAL DRAWINGS FOR

PROPOSED

EXISTING





SAM KACHMAR ARCHITECTS

(p) 617-800-6223 357 HURON AVE. CAMBRIDGE MA, 02138

NOT FOR CONSTRUCTION

ELEVATION SOUTH

JESSE & KIM MOTI

REMAIN

PATCH AS NECESSARY
 EXISTING TRIM DETAILS TO REMAIN
 SEE A-204 FOR TRIM SHEET

SEE STRUCTURAL DRAWINGS FOR

STRUCTURAL SCOPE.


1. TO BE DETERMINED BY

63-65 Clarendon Residence

63 CLARENDON AVENUE CAMBRIDGE MA. 02140

CONSTRUCTION DOCUMENTS Project number Date 2301-6365 09/08/2023 Author

Checker BZA-203 As indicated

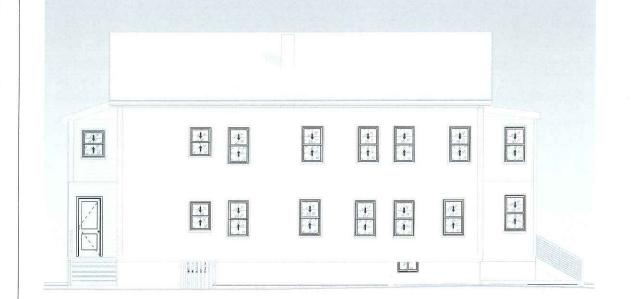


2 PROPOSED - SOUTH ELEVATION 1/4" = 1'-0"




1) EXISTING - SOUTH ELEVATION 3/16" = 1'-0"

EXISTING

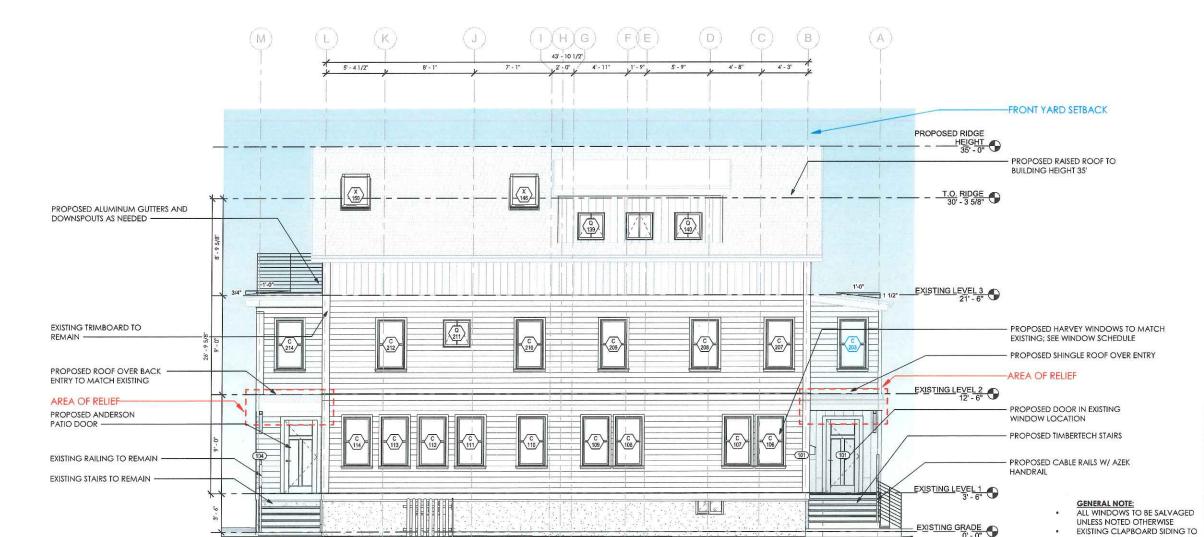

END OF PRESENTATION

63 CLARENDON AVE EXTERIOR VIDEO RENDER

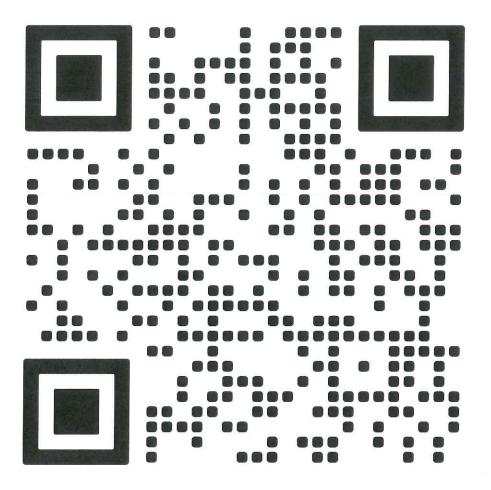

SUPPLEMENTARY SHEETS FOR REFERENCE BELOW



SAM KACHMAR ARCHITECTS

(p) 617-800-6223 www.SKA-MA.com 357 HURON AVE. CAMBRIDGE MA, 02138

PEGISTRATIO

NOT FOR CONSTRUCTION

QR CODE

JESSE & KIM MOTT
63-65 Clarendon Residence
63 CLARENDON AVENUE
CAMBRIDGE MA. 02140

Checked by	Checker
Drawn by	Author
Date	09/08/2023
Project number	2301-6365
Project Status	CONSTRUCTION DOCUMENTS

BZA-300

Scale



1. INFORMATION SHOWN ON THIS PLAN IS THE RESULT OF A FIELD SURVEY PERFORMED BY SPRUHAN ENGINEERING, P.C. AS OF 6/15/2023.

2. DEED REFERENCE: BOOK 76347, PAGE 81
PLAN REFERENCE 1: PLAN 410 OF 1972
PLAN REFERENCE 2: PLAN 215 OF 2020
PLAN REFERENCE 3: PL #57 1-17-2007
PLAN REFERENCE 4: OF84_1977
MIDDLESEX COUNTY SOUTH DISTRICT REGISTRY OF DEEDS

3. THIS PLAN IS NOT INTENDED TO BE RECORDED.


4. I CERTIFY THAT THE DWELLING SHOWN IS NOT LOCATED WITHIN A SPECIAL FLOOD HAZARD ZONE, IT IS LOCATED IN ZONE X, ON FLOOD HAZARD BOUNDARY MAP NUMBER 25017C0419E, IN COMMUNITY NUMBER: 250186, DATED 6/4/2010.

5. THIS PLAN DOES NOT SHOW ANY UNRECORDED OR UNWRITTEN EASEMENTS WHICH MAY EXIST. A REASONABLE AND DILIGENT ATTEMPT HAS BEEN MADE TO OBSERVE ANY APPARENT USES OF THE LAND; HOWEVER THIS NOT CONSTITUTE A GUARANTEE THAT NO SUCH EASEMENTS EXIST.

6. FIRST FLOOR ELEVATIONS ARE TAKEN AT THRESHOLD.

7. NO RESPONSIBILITY IS TAKEN FOR ZONING TABLE AS SPRUHAN ENGINEERING, P.C. ARE NOT ZONING EXPERTS. TABLE IS TAKEN FROM TABLE PROVIDED BY LOCAL ZONING ORDINANCE. CLIENT AND/OR ARCHITECT TO VERIFY THE ACCURACY OF ZONING ANALYSIS.

8. THE ELEVATIONS SHOWN ARE ON A CITY OF CAMBRIDGE DATUM.

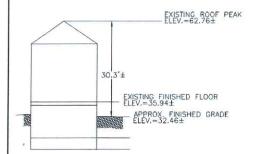


EXISTING PROFILE NOT TO SCALE

FLOOD ELEVATION (CAMBRIDGE FLOOD VIEWER 2022) CAMBRIDGE CITY BASE (FT-CBB) DATUM

Graund Elevation Min:	30.2 ft-CCB
Ground Elevation Max:	34.5 ft-CCB
2070-1%-5LR/SS	NA
2070 - 1% - Precip	N/A
2070 - 10% - \$18/65	N/A
	NA.
2030 - 10% - Preco	19/4
Present stay - 1% - Precip	NA
Present Day - 10% - Precip	NA
FEMA 500-Year	N/A
FEMA 100-Year	N/A
1% - LTFE	N/A
10% - LTFE	N/A

Selected Address: 63 Clarendon Ave.

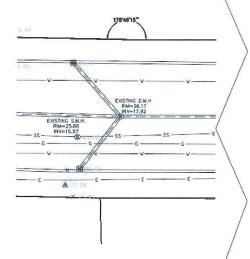

	EXSTANG EXTANGE EXTANG	THEI 3' E AND 1-1 AND HELD ACC PLAN 215 OF 2020
	APRIX, LOCATION OF 6" WAITER LINE STATE APRIX LINE STATE APR	65.50' (DEED) 68.50' (CALC)
	APRX. LOCATION OF 12° DRAIN LINE OF WATER LINE CONNECTION OF 15° SEWER LINE SS	RENDON AVENUE (PUBLIC WAY - 40' WIDE)
25 - 2 - 25 - 25 - 25 - 25 - 25 - 25 -	G APRX. LOCATION OF 6" GAS LINE CONNICTION APRX. LOCATION OF 6" WATER UNE APRX. LOCATION OF 6" WATER UNE E E E E E	
\ \ \ \ \ \ \ \ \ \ \ \ \ \ \ \ \ \ \	APRX, LOCATION OF ELECTRIC LINE	

SCALE 1"=10"					
DATE 7/17/2023	REV	DATE	REVISION	BY	
SHEET 1	63-65 CLARENDON AVENUE				
PLAN NO. 1 OF 1	CAMBRIDGE MASSACHUSETTS				
CLIENT:	EXISTING CONDITION PLAN			SHEET NO	
DRAWN BY s.g.s	-				
CHKD BY			TER NOLAN & ASSOCIATES LLC ID SURVEYORS/CIVIL ENGINEERING CONSULTANTS RO IEWETT STORET SHITE I NEWTON MA 0245R		

GRAPHIC SCALE (IN FEET) 1 inch = 10 ft.

THEN NAME A ADDITION THE THE PROPERTY FOR CONTRICTION BEARS, METHOD, TOHOUGH, OF PROCEEDING VIRIGID OF THE CHRISTICS, AND THE WESTER OF FRANCE DECEMBER. THE CHRISTICS SHE CHRISTICS OF THE PROPERTY OF CHRISTICS OF THE METHOD MICROSORY WITH THE CHRISTIC PROMISES.

THE CHRISTIC PROCEDURE ADDITIONS AND THE PROPERTY OF CHRISTICS OF THE PROPERTY OF THE CHRISTICS OF T COPY AND THE DESIGNATION AND THE SECOND STATES AND AND AND AND STATES AND THE SECOND STATES AND AND AND AND STATES AND THE SECOND STATES AND AND AND AND STATES AND THE SECOND STATES AND AND AND AND STATES AND THE SECOND STATES AND AND AND STATES AND THE S

N/F ARCHDIOCESE CENTRAL HIGH SCHOOL INC. BK. 46517, PG. 0099

N 4218'20" E EXISTING SHED PARCEL ID: 184-3 4,000 S.F. EXISTING STEPS

N/F LARCOMBE, JILL LOUISE BK. 35715, PG. 0342 #63-65 EXISTING WOOD-FRAMED RESIDENTIAL DWELLING FF=35.94

(TAKEN AT THRESHOLD)

80 JEWETT STREET, SUITE 1, NEWTON, MA. 02458
PHONE: 857 891 7478
EMAIL: pnolan@pnasurveyors.com

LEGEND

IRON PIN/PIPE STONE POST TREE TREE STUMP

SHRUBS/FLOWERS

SEWER MANHOLE

DRAIN MANHOLE

WATER MANHOLE

ELECTRIC MANHOLE

ELECTRIC HANDHOLE

EXISTING BUILDING

RETAINING WALL

STONE WALL FENCE

TREE LINE SEWER LINE DRAIN LINE WATER LINE

GAS LINE

OVERHEAD WIRES

CONTOUR LINE (MJR) CONTOUR LINE (MNR)

UNDERGROUND ELECTRIC LINE

PL #57 1-17-2007

★ 36.40

_E__E__E__E__

CATCH BASIN

WATER VALVE

HYDRANT

GAS VALVE

UTILITY POLE

LIGHT POLE

MANHOLE SPOT GRADE TOP OF WALL BOTTOM OF WALL

BOUND

SIGN

BOLLARD

⊡

0

(3)

0

Ш

五

(ii)

0

中

(00)

-145-

SAM KACHMAR ARCHITECTS

(p) 617-800-6223 www.SKA-MA.com 357 HURON AVE. CAMBRIDGE MA, 02138

REGISTRATIONS:

NOT FOR CONSTRUCTION

PLAN PLOT

KIM MOT


ంర


JESSE

Clarendon Residence AVENUE A. 02140 63 CLARENDON A CAMBRIDGE MA. -65

CONSTRUCTION **DOCUMENTS** Project number Date 2301-6365 09/08/2023 Drawn by Author Checker

BZA-301

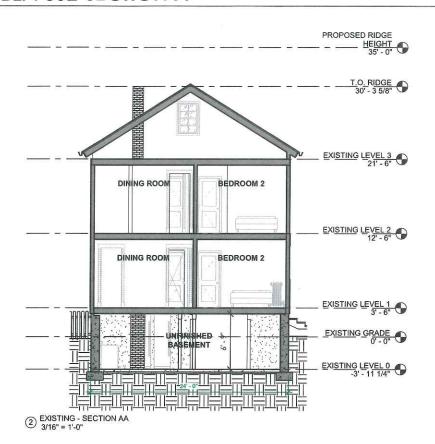

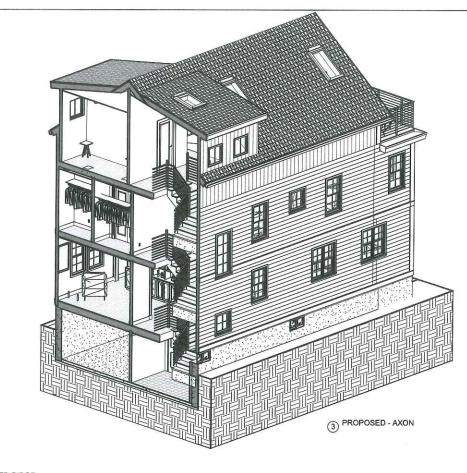



(p) 617-800-6223 www.SKA-MA.com 357 HURON AVE. CAMBRIDGE MA, 02138

NOT FOR CONSTRUCTION

SECTION A

JESSE & KIM MOTT


63-65 Clarendon Residence

63 CLARENDON AVENUE CAMBRIDGE MA. 02140

CONSTRUCTION DOCUMENTS Project Status 2301-6365 09/08/2023 Author Checker

BZA-302

As indicated

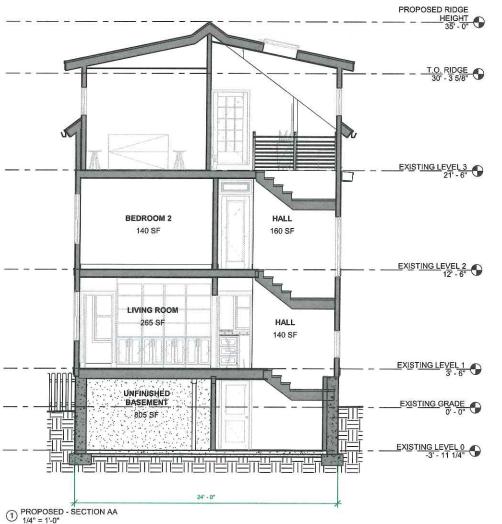

From:

May Wong <mrsmaywong@gmail.com>

Sent:

Tuesday, September 5, 2023 8:31 AM

To:

Pacheco, Maria

Cc: Subject: Jesse Mott (US); Kimmy Mott Support for 63 Clarendon Ave

To Whom it May Concern:

My name is May Wong and I live at 50 Churchill Ave, Apt 336 Cambridge MA 02140. I live at Burns Apts, one house away from my neighbors Kimberly and Jesse Mott. I support their application for a special permit for their house at 63 Clarendon, Cambridge MA 02140.

Sincerely, May Wong

From:

Ellie Chen <elliechen33@gmail.com>

Sent:

Tuesday, September 5, 2023 12:24 PM

To:

Pacheco, Maria

Cc:

kimberly.c.mott@gmail.com

Subject:

Letter of Support: 63 Clarendon Ave Special Permit

Hello,

My name is Szu-Yuan Chen and I live at 51 Churchill Ave, behind 63 Clarendon Ave. I am writing to state my support for my neighbors, Kimberly Mott and Jesse Mott in their application for a special permit for their home at 63 Clarendon Ave., Cambridge, MA 02140.

Sincerely, Szu-Yuan Chen 734-709-4220

From:

angel yang <ayang6855@gmail.com>

Sent:

Tuesday, September 5, 2023 2:37 PM

To:

Pacheco, Maria

Cc:

kimberly.c.mott@gmail.com

Subject:

The support for the permit for renovation for the property at 63 Clarendon Ave

Hello,

My name is Rongna Yang and I live at <u>21 Washburn Ave</u>, Unit2 Cambridge, MA 02140. I am writing to state my support for my neighbors, Kimberly Mott and Jesse Mott in their application for a special permit for their home at <u>63 Clarendon</u> ave, cambridge Ma 02140.

Sincerely

Rongna Yang
21 Washburn ave Unit2
Cambridge Ma 02140.
978-201-3022
ayang6855@gmail.com

From:

Chi-Chi Zhang <chichi.xq.zhang@gmail.com>

Sent:

Tuesday, September 5, 2023 2:59 PM

To:

Pacheco, Maria

Subject:

Support of 63 Clarendon, Cambridge MA 02140 Renovation

To Whom it May Concern:

My name is Chi-Chi Zhang and I live at 113 Antrim St, Unit 1, Cambridge, 02139. I support Kimberly and Jesse Mott's application for a special permit for their house at 63 Clarendon, Cambridge MA 02140.

Sincerely, Chi-Chi Zhang 617-480-0656

From:

jillcrockett25@gmail.com

Sent:

Tuesday, September 5, 2023 8:46 PM

To:

Pacheco, Maria

Cc: Subject: kimberly.c.mott@gmail.com Support for zoning variance

Dear Ms. Pacheco

This is to indicate my support for Kimberly and Jesse Mott's application for a zoning variance for their house at 63 Clarendon Ave, Cambridge MA 02140. I live immediately next door at 59-61 Clarendon Ave in Cambridge.

Sincerely
Jill Crockett

Sent from App for Gmail



City of Cambridge

MASSACHUSETTS

BOARD OF ZONING APPEAL

831 Mass Avenue, Cambridge, MA. (617) 349-6100

BZA

POSTING NOTICE - PICK UP SHEET

The undersigned picked up the notice board for the Board of Zoning Appeals Hearing.

Name:	Steven Hoheb (Print)	Date: 8/28/23
Address: _	63 Claren Lora	Are.
Case No	BZA-2337/6	
Hearing Dat	e: 9/14/23	*

Thank you, Bza Members